



Republic of the Philippines
SOUTHERN LUZON STATE UNIVERSITY
Lucban, Quezon

REQUEST FOR QUOTATION

REPAIR, FABRICATION AND INSTALLATION OF GLASS ALUMINUM PARTITION, DOORS AND WINDOWS AT SLSU MAIN AND EXTENSION CAMPUSES (PPF)

**Purchase Request No. 2023-07-1631
Approved Budget for the Contract: ₱ 740,253.00**


The Southern Luzon State University through the Bids and Awards Committee invites interested firms/supplier to submit quotation for the procurement of **Repair, Fabrication and Installation of Glass Aluminum Partition, Doors and Windows at SLSU Main and Extension Campuses (PPF)** to apply the sum of **Seven Hundred Forty Thousand and Two Hundred Fifty-Three Pesos Only (₱ 740,253.00)** inclusive of VAT, being the **Approved Budget for the Contract (ABC)**, details as follows:

| Qty. | Unit | ITEM/S DESCRIPTION |
|------|------|---|
| 1 | lot | REPAIR, FABRICATION AND INSTALLATION OF GLASS ALUMINUM PARTITION, DOORS AND WINDOWS AT SLSU MAIN AND EXTENSION CAMPUSES (PPF) |
| | | |
| | | |
| | | *see attached documents for reference |

1. The quotation must be submitted (can also be send thru email at the contact details listed below) or to the Office of the Procurement Office/Bids and Awards Committee, Southern Luzon State University, 2nd Flr. Hermano Puli Building, and shall be received by the Committee.

E-mail : slsuprocedurement2021@gmail.com

2. The SLSU reserves the right to reject any or all quotations and/or proposals and waive any formalities/informalities therein and to accept such bids it may consider as most advantageous to the agency and to the government. Southern Luzon State University SLSU neither assumes any obligation for whatsoever losses that may be incurred in the preparation of bids, nor does it guarantee that an award will be made.


Maridel C. Zaballa
OIC, Procurement office
Southern Luzon State University
Lucban, Quezon
Tel. No.: (042)540-6519



Republic of the Philippines
SOUTHERN LUZON STATE UNIVERSITY
 Lucban, Quezon
REQUEST FOR QUOTATION

| | | |
|--------------------|-------------------------------|----------------------|
| Office/End-User: | Physical Plant and Facilities | Date: |
| COMPANY NAME: | | PR No.: 2023-07-1631 |
| ADDRESS : | | |
| TEL. NO./FAX NO. : | | TIN No.: |

Please quote your lowest price on the item(s) listed below, subject to the Terms & Conditions stated below and submit your quotation duly signed by your representative not later than _____ of _____ in the return envelope attached herewith to the Procurement office.

TERMS and CONDITIONS

1. All entries must be typewritten or legibility written.
2. Delivery period within _____ upon conforme of the approved Purchase Order (P.O). Administrative penalties to Sec. 69 of the Revised IRR-RA 1984 shall be imposed for non-delivery without valid reason.
3. Warranty shall be for a minimum of three (3) months for Supplies & Materials; (1) one year for Equipment from date of acceptance by the end-user.
4. Price validity shall be for a period of sixty (60) calendar days.
5. Suppliers required to submit updated documents yearly such as G-EPS Registration, Certificate of Tax, Mayor's Permit, DTI, Bank Name/Account and Branch for evaluation of the Procurement Office upon submission of the quotation.
6. Bidders shall submit complete specifications showing products certification, if applicable.
7. Please indicate the brand for each Items being offered.
8. The Approved budget ceiling for this procurement is PHP 740,253.00.

MARIDEL C. ZABELLA
OIC, Procurement Office

| Item # | Qty. | Unit | ITEM/S DESCRIPTION | Unit Price | Total Cost |
|--------|------|------|---|------------|------------|
| | 1 | lot | REPAIR, FABRICATION AND INSTALLATION OF GLASS ALUMINUM PARTITION, DOORS AND WINDOWS AT SLSU MAIN AND EXTENSION CAMPUSES (PPF) | | |
| | | | *see attached documents for reference | | |
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|---|-----------------|
| Source of Fund: | Warranty: |
| Delivery Period: | Price Validity: |
| <p><i>After having carefully read & accepted your General Conditions, We quote you on the item(s) at prices note above. If the space of provided on the Delivery Period, Warranty & Price Validity are left blank, it means that I concur w/ the Terms & Conditions specified by SLSU Procurement Office.</i></p> | |

 Printed Name/Signature/Date



REPUBLIC OF THE PHILIPPINES
SOUTHERN LUZON STATE UNIVERSITY
PHYSICAL PLANT AND FACILITIES



| | |
|-------------------------|---|
| PROJECT TITLE: | Fabrication and Installation of Glass Partition at OSAS Dean's Office, CABHA Bldg |
| PROJECT LOCATION: | OSAS, 2nd Floor CABHA Bldg |
| OWNER: | Southern Luzon State University |
| MODE OF IMPLEMENTATION: | by Contract |
| DURATION: | 6 calendar days for 4 workers |

| SUMMARY | | | | |
|---|-------------|----------------|--------------------------|------------|
| ITEM | DESCRIPTION | MATERIALS COST | LABOR AND EQUIPMENT COST | TOTAL COST |
| 1 | Glass Works | | | |
| TOTAL ESTIMATED DIRECT COST | | | | - |
| OVERHEAD, CONTINGENCIES AND MISC. (OCM) | | | | - |
| CONTRACTOR'S PROFIT | | | | - |
| VALUE ADDED TAX (VAT) | | | | - |
| TOTAL ESTIMATED PROJECT COST | | | | - |

[Handwritten signature]

Gunnica?
Polillo -?
Senior High -?

REPUBLIC OF THE PHILIPPINES
SOUTHERN LUZON STATE UNIVERSITY
PHYSICAL PLANT AND FACILITIES

| | |
|-------------------------|---|
| PROJECT TITLE: | Fabrication and Installation of Glass Partition at OSAS Dean's Office, CABHA Bldg |
| PROJECT LOCATION: | OSAS, 2nd Floor CABHA Bldg |
| OWNER: | Southern Luzon State University |
| MODE OF IMPLEMENTATION: | by Contract |
| DURATION: | 6 calendar days for 4 workers |

BILL OF MATERIALS

| ITEM | DESCRIPTION | Qty | Unit | Direct Cost | Total Materials Cost |
|------|-------------|-----|------|-------------|----------------------|
|------|-------------|-----|------|-------------|----------------------|

I. Glass Works

| | | | | | |
|------------------|--|---|-----|--|---|
| 1 | Fabrication & Installation of Glass partition with Aluminum Powder Coated White Frame (2"x6") of 216"x 97" (measurement of whole partition) Fabrication includes: -Clear Glass (with Sticker as indicated on drawing Plans) -Sliding Door 1 set -Sliding Window (2 sets) (See attached Drawing Plans for details) | 1 | lot | | |
| SUB-TOTAL | | | | | - |



Project: Fabrication and Installation of Glass Partition at OSAS Dean's office, CABHA Bldg

Location: OSAS, 2nd Floor, SLSU Main Campus, Lucban, Quezon

Implementation: by Contract

Duration: 6 Working Days for 4 Workers

SCOPE OF WORKS

I. Glass Works

- Measurement/ Verification of measurement of materials to be fabricated
- Fabrication of Aluminum Partition
- Installation of Fabricated materials complete with accessories
- The contractor must secure the stability of the of the partition after installation.

PREPARED BY:

RONELITO O. SAN JOSE, PME
Head, Physical Plant and Facilities

REVIEWED BY:


ENGR. MELVIN A. MAKIPAGAY
Director, Planning and Development Office
(Infrastructure)

RECOMMENDING APPROVAL:

DR. FREDERICK T. VILLA
VP, Administration and Financial Affairs

APPROVED BY:


DR. DORACIE B. ZOLETA-NANTES
University President

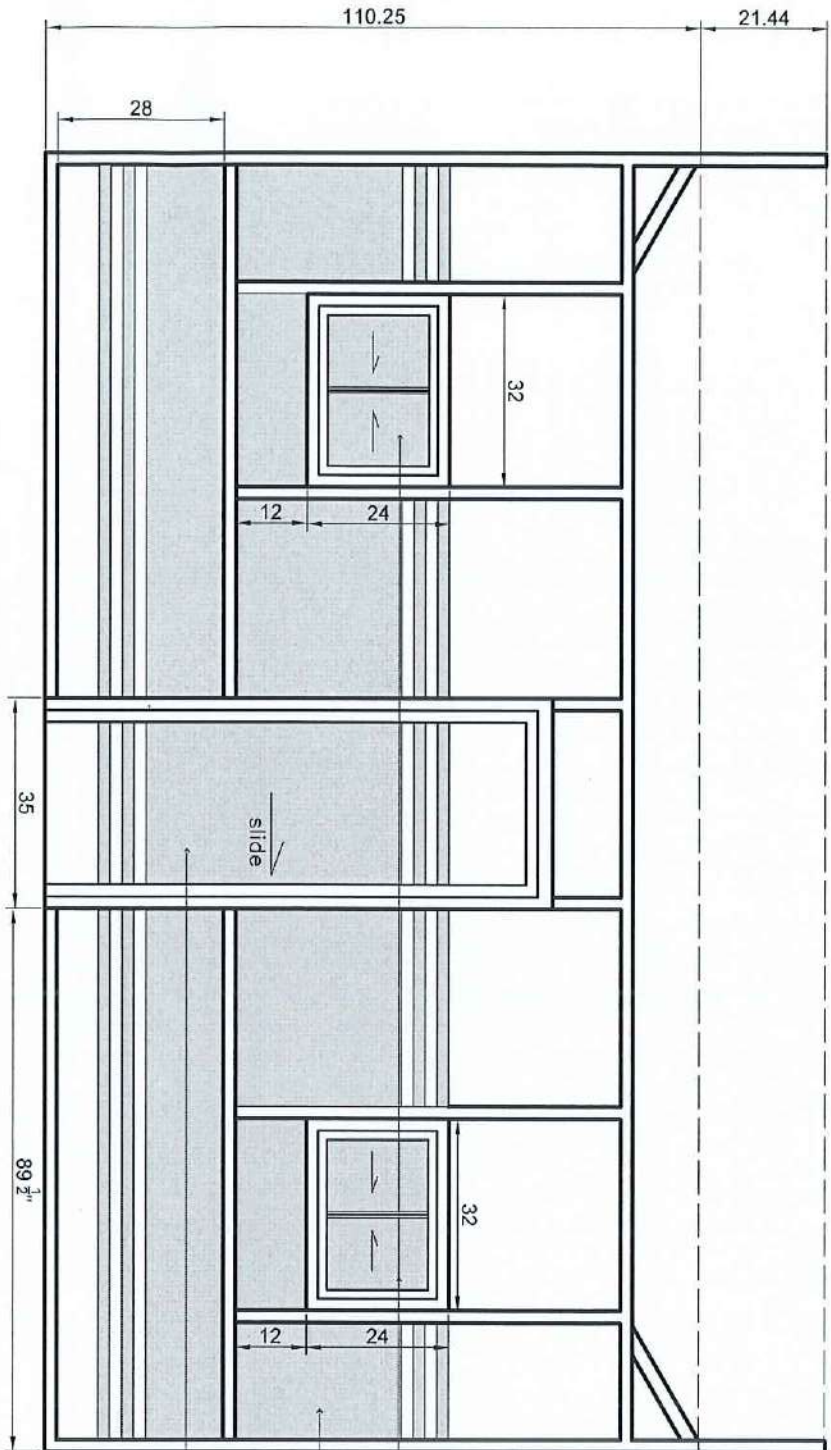

NOTE: MEASUREMENTS ARE IN INCHES

- SLIDING ACCESS WINDOW
w/ FROSTED GLASS STICKER
- FROSTED GLASS
STICKER
- SLIDING DOOR w/ LOCK
AND HANDLE

| | | | | | | |
|--|--|--|--|---|---|-----------------------------|
| <p>PROJECT TITLE</p> <p>FABRICATION AND INSTALLATION OF GLASS PARTITION AT DEAN'S OFFICE 3RD FLOOR, SAN JESU</p> <p>ADDRESS: 8140 SAN CARLOS LUTHERAN, QUETZ</p> | <p>PREPARED BY:</p> <p>ENGR. ROBERTO O. SAN JOSE</p> <p>HEAD ARCHITECT</p> | <p>REVIEWED BY:</p> <p>ENGR. MELVYN M. MARIANO</p> <p>SENIOR ARCHITECT</p> | <p>RECOMMENDING APPROVAL:</p> <p>DR. FREDERICK T. VILLA</p> <p>VP ADMINISTRATION AND FINANCIAL AFFAIRS</p> | <p>APPROVED BY:</p> <p>DR. DORACIE B. ZOLETANANTES</p> <p>UNIVERSITY ENGINEER</p> | <p>SHEET CONTENTS:</p> <p>GLASS PARTITION</p> | <p>SHEET NO.</p> <p>A-1</p> |
|--|--|--|--|---|---|-----------------------------|

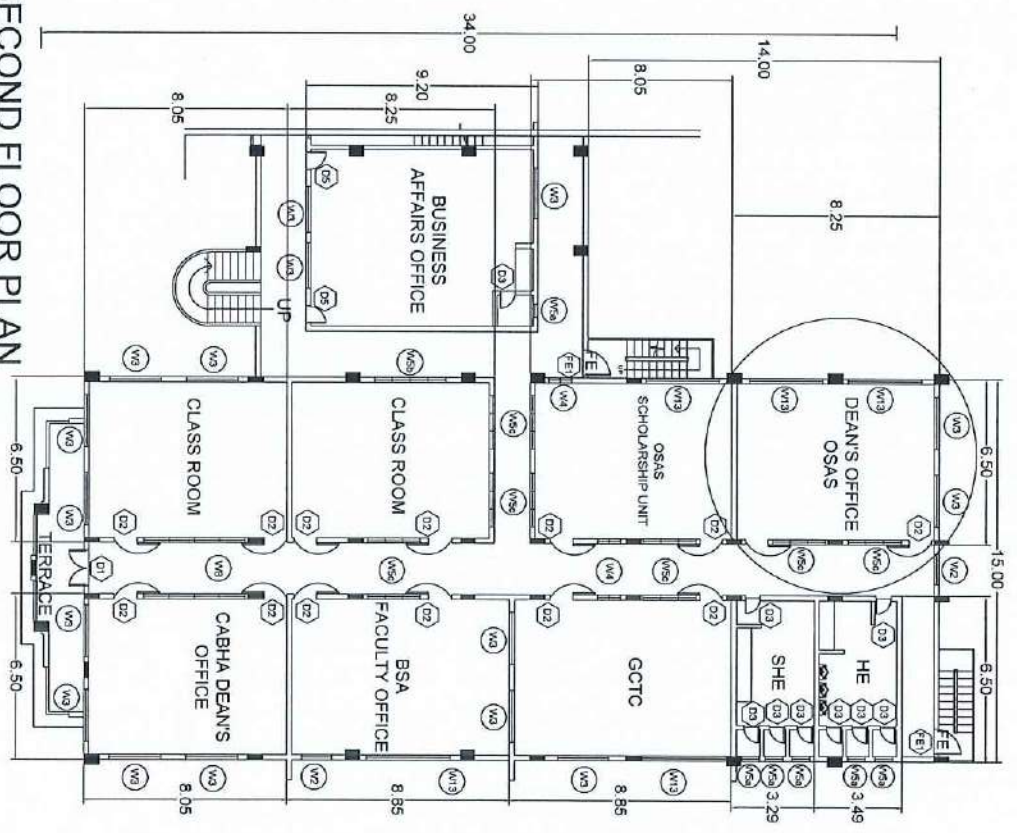

SECOND FLOOR PLAN

SCALE: 1:100 H

| | | | | | | |
|--|---|---|--|---|------------------------|-----------------------------|
| <p>PROJECT TITLE</p> <p>FABRICATION AND INSTALLATION OF GLASS PARTITION AT OSAS DEAN'S OFFICE 2ND FLOOR OSAS BLDG</p> <p>NO. 0015 2523 MAN. CAMPUS 3. ULSATM. OFFICE</p> | <p>PREPARED BY:</p> <p>ENGR. RONENITO O. SAN JOSE</p> <p>HEAD ARCHITECT</p> | <p>REVIEWED BY:</p> <p>ENGR. MARIANNA M. MONTENEGRO</p> <p>SENIOR ARCHITECT</p> | <p>RECOMMENDING APPROVAL</p> <p>DR. FREDERICK T. VILLA</p> <p>VP. ADMINISTRATION AND FINANCIAL AFFAIRS</p> | <p>APPROVED BY:</p> <p>DR. DORACIE B. POLETA-NANTES</p> <p>UNIVERSITY PRESIDENT</p> | <p>SHEET CONTENTS:</p> | <p>SHEET NO.</p> <p>A-2</p> |
|--|---|---|--|---|------------------------|-----------------------------|



REPUBLIC OF THE PHILIPPINES
SOUTHERN LUZON STATE UNIVERSITY
PHYSICAL PLANT AND FACILITIES



| | |
|-------------------------|--|
| PROJECT TITLE: | Repair, fabrication and Installation of Doors and Windows for DLB at CIT |
| PROJECT LOCATION: | DLB, SLSU Main Campus, Lucban, Quezon |
| OWNER: | Southern Luzon State University |
| MODE OF IMPLEMENTATION: | by Contract |
| DURATION: | 6 calendar days for 2 workers |

| | | | | |
|--|--|--|--|--|
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|--|--|--|--|--|

SUMMARY

| ITEM | DESCRIPTION | MATERIALS COST | LABOR AND EQUIPMENT COST | TOTAL COST |
|--|-------------|----------------|--------------------------|------------|
| II | Doors | | | |
| III | Windows | | | |
| <i>TOTAL ESTIMATED DIRECT COST</i> | | | | - |
| <i>OVERHEAD, CONTINGENCIES AND MISC. (OCM)</i> | | | | - |
| <i>CONTRACTOR'S PROFIT</i> | | | | - |
| <i>VALUE ADDED TAX (VAT)</i> | | | | - |
| TOTAL ESTIMATED PROJECT COST | | | | - |

REPUBLIC OF THE PHILIPPINES
SOUTHERN LUZON STATE UNIVERSITY
PHYSICAL PLANT AND FACILITIES

| | |
|-------------------------|--|
| PROJECT TITLE: | Repair, fabrication and Installation of Doors and Windows for DLB at CIT |
| PROJECT LOCATION: | DLB, SLSU Main Campus, Lucban, Quezon |
| OWNER: | Southern Luzon State University |
| MODE OF IMPLEMENTATION: | by Contract |
| DURATION: | 6 calendar days for 2 workers |

BILL OF MATERIALS

| ITEM | DESCRIPTION | Qty | Unit | Direct Cost | Total Materials Cost |
|------|-------------|-----|------|-------------|----------------------|
|------|-------------|-----|------|-------------|----------------------|

I. Doors

| | | | | | |
|------------------|--|---|------|--|---|
| 1 | Fabrication & Installation of 2"x4" Heavy Duty Door Jamb (with Powder Coated White Aluminum Frame) and a 880mmx2100mm Heavy Duty Swing Door with 6mm thk Smoked Glass (with powder coated white Frame) Complete with accessories (See attached drawing for details) | 2 | sets | | |
| SUB-TOTAL | | | | | - |

II. Windows

| | | | | | |
|------------------|--|---|------|--|---|
| 1 | Fabrication & Installation of Jalousie Windows with Aluminum Frame Powder Coated White 2"x4" (6mm thk Clear Glass) including 6mm fixed Clear Glass (2Panel) (See Plan Attachment for Details) | 4 | sets | | |
| 2 | Fabrication & Installation of Jalousie Windows with Aluminum Frame Powder Coated White 2"x4" (6mm thk Clear Glass) including 6mm fixed Clear Glass (3Panel) (See Plan Attachment for Details) | 2 | sets | | |
| SUB-TOTAL | | | | | - |



Project: Repair, Fabrication and Installation of Door and Windows for DLB at CIT
Location: SLSU Main Campus, Lucban, Quezon
Implementation: by Contract
Duration: 6 Working Days for 2 Workers

SCOPE OF WORKS

I. Demolition/ Clearing

- a. The contractor must provide workers to demolish the existing doors and windows at the location of the site.
- b. The contractor is responsible for clearing the doors where the new doors are to be installed

II. Doors

- Measurement/ Verification of measurement of materials to be fabricated
- Fabrication of Aluminum Frame
- Installation of Fabricated materials complete with accessories

III. Windows

- Measurement/ Verification of measurement of materials to be fabricated
- Fabrication of Aluminum Frame
- Installation of Fabricated materials complete with accessories

PREPARED BY:

RONELITO O. SAN JOSE, PME
Head, Physical Plant and Facilities

REVIEWED BY:


ENGR. MELVIN A. MAKIPAGAY
Director, Planning and Development Office
(Infrastructure)

RECOMMENDING APPROVAL:

DR. FREDERICK T. VILLA
VP, Administration and Financial Affairs

APPROVED BY:

DR. DORACIE B. ZOLETA-NANTES
University President

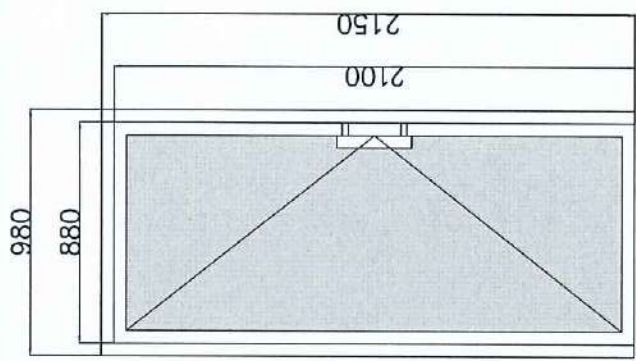


DLB 2

2"X4" PCAF WHITE
ALUMINUM DOOR JAMB

880X2100mm ALUMINUM SWING
DOOR WITH 6mm thk.
SMOKED GLASS

COMPLETE WITH ACCESSORIES
HEAVY DUTY

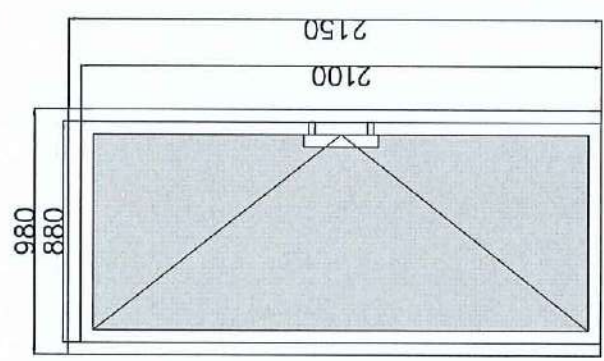

DLB 1


2"X4" PCAF WHITE
ALUMINUM DOOR JAMB

880X2100mm ALUMINUM SWING
DOOR WITH 6mm thk.
SMOKED GLASS

COMPLETE WITH ACCESSORIES
HEAVY DUTY

REPAIR, FABRICATION AND INSTALLATION OF ALUMINUM SWING DOOR FOR
DLB 1&2

| | | | | | |
|---|----------------------------|---------------------------|--|---|-----------------|
| PROJECT TITLE | PREPARED BY: | REVIEWED BY: | RECOMMENDS APPROVAL: | APPROVED BY: | SHEET CONTENTS: |
| REPAIR, FABRICATION AND INSTALLATION OF ALUMINUM SWING DOOR FOR DLB 1&2 | ENGR. ROBERTO O. SAN JESSE | ENGR. MERWIN M. VILLALBA | FREDERICK VILLA, DIT SR. ENGR. VILLALBA | DORACIE ZOLETANANTES, PHD ENGR. ZOLETANANTES | 1 |
| DATE: 08/11/2023 | SCALE: 1:1 | SECTION: PARTIAL AND FULL | NO. OF SHEETS: 1 | NO. OF SHEETS: 1 | |


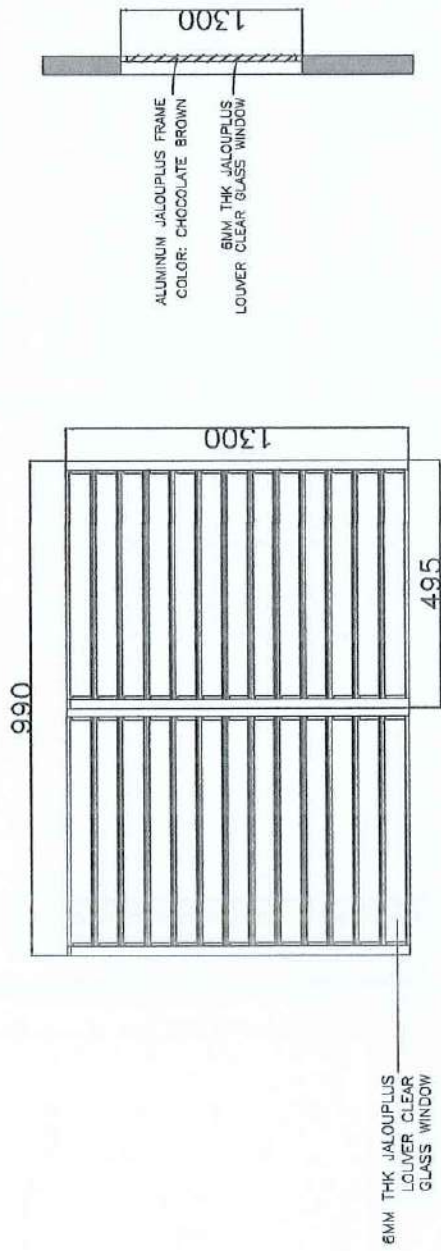


JALOUPLUS WINDOW 2-PANEL

4 SETS

Repair, Fabrication and
Installation of Jalousie Windows
for DLB 1 & 2

| | | | | | |
|--|---|---|---|--|-----------------------------------|
| PROJECT TITLE REPAIR, FABRICATION AND INSTALLATION OF ALUMINUM JALOUPLUS WINDOW FOR ADULTS, ELDERLY, DISABLED AND VISUALLY IMPAIRED | PREPARED BY ENGR. ROBERT O. SAN JACINTE REGISTERED PROFESSIONAL ENGINEER NO. 10000 | REVIEWED BY ENGR. NEIL W. MCGAY REGISTERED PROFESSIONAL ENGINEER NO. 10000 | RECOMMENDING APPROVAL FREDERICK VILLA, DIT REGISTERED PROFESSIONAL ARCHITECT NO. 10000 | APPROVED BY DIREC. J. ZOLITANANTES, PHD UNIVERSITY PRESIDENT | SHEET CONTENTS ALUMINUM WINDOW |
| | | | | | 2 |

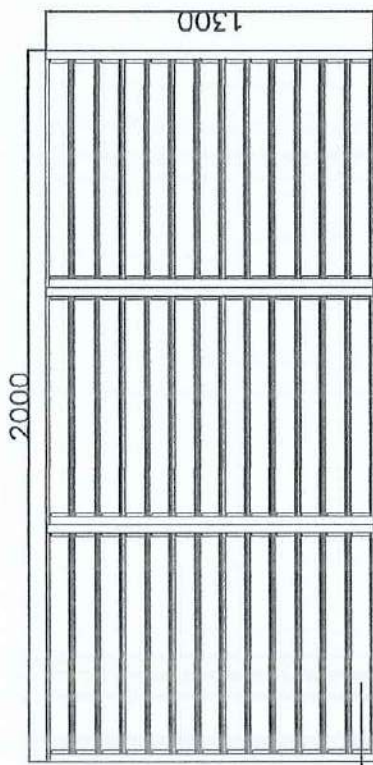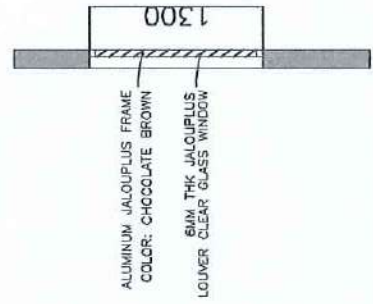

6MM THK JALOUSIE
LOUVER CLEAR
GLASS WINDOW

JALOUSIE WINDOW 3-PANEL

2 SETS

Repair, Fabrication and
Installation of Jalousie Windows
for DLB 1 & 2

| | | | | | |
|--|--|---|--|---|-----------------|
| PROJECT TITLE | PREPARED BY: | REVIEWED BY: | RECOMMENDING APPROVAL: | APPROVED BY: | SHEET CONTENTS: |
| REPAIR, FABRICATION AND INSTALLATION OF ALUMINUM JALOUSIE WINDOWS FOR BUILDINGS AND SCHOOL BUILDINGS | ENGR. ROBERTO O. SAN JACINTO REGISTERED PROFESSIONAL ENGINEER | ENGR. MELVIN M. MARAFACAY REGISTERED PROFESSIONAL ENGINEER | FREDERICK T. VILLA, DIT REGISTERED PROFESSIONAL ARCHITECT | DORACE B. ZORRANANTE, PHD UNIVERSITY PRESIDENT | 3 |



REPUBLIC OF THE PHILIPPINES
SOUTHERN LUZON STATE UNIVERSITY
PHYSICAL PLANT AND FACILITIES



| | |
|-------------------------|---|
| PROJECT TITLE: | Fabrication and Installation of Aluminum Swing Door at SLSU Polillo |
| PROJECT LOCATION: | SLSU Polillo Campus, Polillo, Quezon |
| OWNER: | Southern Luzon State University |
| MODE OF IMPLEMENTATION: | by Contract |
| DURATION: | 15 working days for 2 workers |

| | | | | |
|---------|--|--|--|--|
| SUMMARY | | | | |
|---------|--|--|--|--|

| ITEM | DESCRIPTION | MATERIALS COST | LABOR AND EQUIPMENT COST | TOTAL COST |
|--|-------------|----------------|--------------------------|------------|
| I | Doors | - | - | - |
| <i>TOTAL ESTIMATED DIRECT COST</i> | | | | - |
| <i>OVERHEAD, CONTINGENCIES AND MISC. (OCM)</i> | | | | - |
| <i>CONTRACTOR'S PROFIT</i> | | | | - |
| <i>VALUE ADDED TAX (VAT)</i> | | | | - |
| <i>TOTAL ESTIMATED PROJECT COST</i> | | | | - |

REPUBLIC OF THE PHILIPPINES
SOUTHERN LUZON STATE UNIVERSITY
PHYSICAL PLANT AND FACILITIES

| | |
|-------------------------|---|
| PROJECT TITLE: | Fabrication and Installation of Aluminum Swing Door at SLSU Polillo |
| PROJECT LOCATION: | SLSU Polillo Campus, Polillo, Quezon |
| OWNER: | Southern Luzon State University |
| MODE OF IMPLEMENTATION: | by Contract |
| DURATION: | 15 working days for 2 workers |

BILL OF MATERIALS

| ITEM | DESCRIPTION | Qty | Unif | Direct Cost | Total Materials Cost |
|------------------|---|-----|------|-------------|----------------------|
| I. Doors | | | | | |
| 1 | 0.85mx2.1m Aluminum Swing Door Framed with Powder Coated Aluminum Frame White w/ 1/4" thk Glass and 2"x4" Aluminum Jamb complete with Handle and Accessories (Faculty Office) | 1 | set | | |
| 2 | 0.90mx2.12m Aluminum Swing Door Framed with Powder Coated Aluminum Frame White w/ 1/4" thk Glass and 2"x4" Aluminum Jamb complete with Handle and Accessories (registrar's office) | 1 | set | | |
| 3 | 1.02mx2.1m Aluminum Swing Door Framed with Powder Coated Aluminum Frame White w/ 1/4" thk Glass and 2"x4" Aluminum Jamb complete with Handle and Accessories (Dean's Office) | 1 | set | | |
| 4 | 1.24mx2.13m Aluminum Double Swing Door Framed with Powder Coated Aluminum Frame White w/ 1/4" thk Glass and 2"x4" Aluminum Jamb complete with Handle and Accessories (Library) | 1 | set | | |
| 5 | 1.11mx2.17m Aluminum Swing Door Framed with Powder Coated Aluminum Frame White w/ 1/4" thk Glass and 2"x4" Aluminum Jamb complete with Handle and Accessories (room 301 Door 2) | 1 | set | | |
| 6 | 1.08mx2.17m Aluminum Double Swing Door Framed with Powder Coated Aluminum Frame White w/ 1/4" thk Glass and 2"x4" Aluminum Jamb complete with Handle and Accessories (room 201 Door 2) | 1 | set | | |
| SUB-TOTAL | | | | | - |



Project: Fabrication and Installation of Aluminum Swing Door of SLSU Polillo
Location: SLSU Polillo Campus, Polillo, Quezon
Implementation: by Contract
Duration: 15 Working Days for 2 Workers

SCOPE OF WORKS

I. Doors

- Measurement/ Verification of measurement of materials to be fabricated
- Fabrication of Aluminum Frame with 6mm thk clear glass
- Installation of Fabricated materials complete with accessories

PREPARED BY:

RONELITO O. SAN JOSE, PME
Head, Physical Plant and Facilities

REVIEWED BY:

ENGR. MELVIN A. MAKIPAGAY
Director, Planning and Development Office
(Infrastructure)

RECOMMENDING APPROVAL:

DR. FREDERICK T. VILLA
VP, Administration and Financial Affairs

APPROVED BY:


DR. DORACIE B. ZOLETA-NANTES
University President

Length: 14.6 CM
Width: 2.8 CM
Height: 4.3 CM
Color: Silver
Screws Included


14.6 CM




2.8 CM

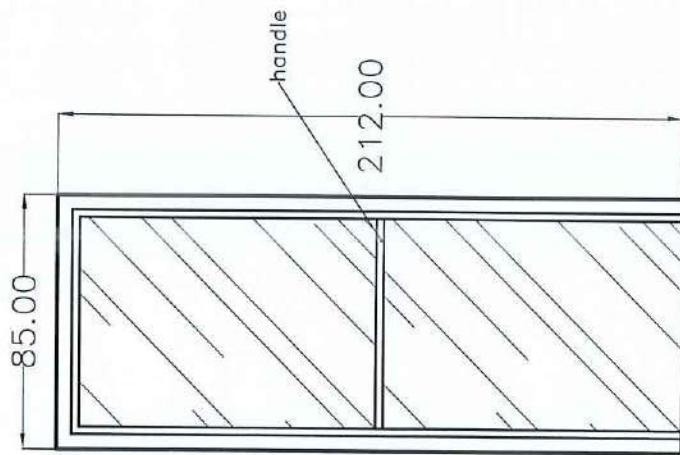

PCAF White Single Swing Door
 6mm thk clear glass
 2"x4" PCAF White Jamb
 complete w/ handle and mortise lock
 1 SET
 FACULTY OFFICE

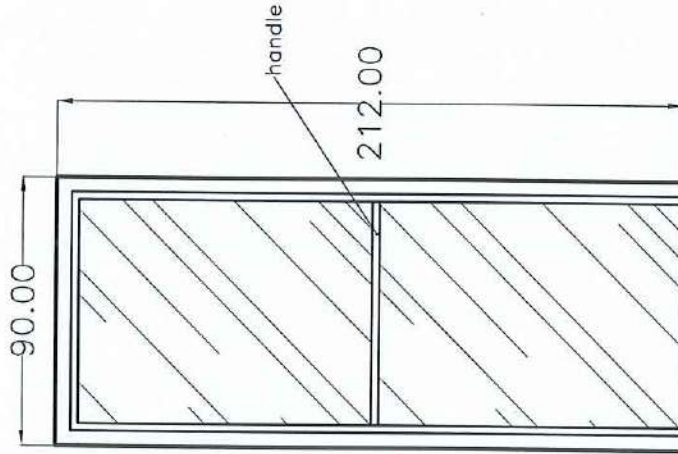


PCAF White Single Swing Door
 6mm thk clear glass
 2"x4" PCAF White Jamb
 complete w/ handle and mortise lock
 1 SET
 REGISTRAR'S OFFICE

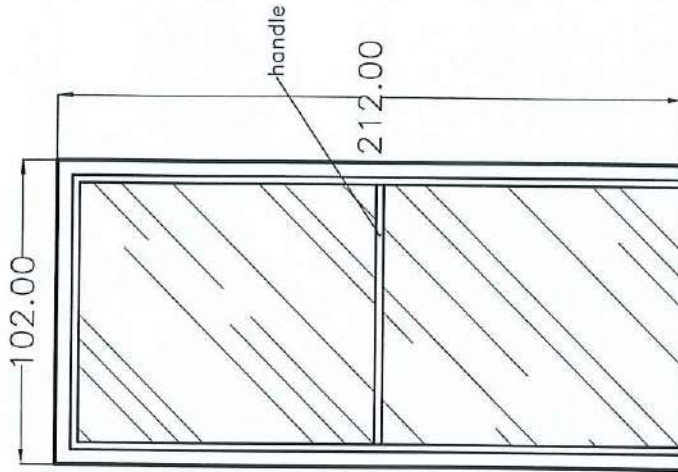


PCAF White Single Swing Door
 6mm thk clear glass
 2"x4" PCAF White Jamb
 complete w/ handle and mortise lock
 1 SET
 DEAN'S OFFICE


| PROJECT TITLE | PREPARED BY: | REVIEWED BY: | RECOMMENDING APPROVAL: | APPROVED BY: | SHEET CONTENTS: | SHEET NO. |
|---|--|---|---|---|-----------------|-----------|
| FABRICATION AND INSTALLATION OF ALUMINUM SWING DOOR FOR MAIN BLDG OF ISLU PULLO CAMPUS <small>REVISED: 1.2011 POLYESTER/PAVILION/POULLO QUAY</small> | ENGR. RONEL TORO SAN JOSE <small>HEAD PERSONNEL UNIT ARCHITECTURE</small> | <i>[Signature]</i> <small>ENGR. MELVIN MANGIPANGAN SENIOR ARCHITECT</small> | DR. FREDERICK T. VILLA <small>VP FOR FINANCIAL AFFAIRS</small> | <i>[Signature]</i> <small>DR. DORACIE B. ZOLETA-NANTES UNIVERSITY PRESIDENT</small> | | 1 |

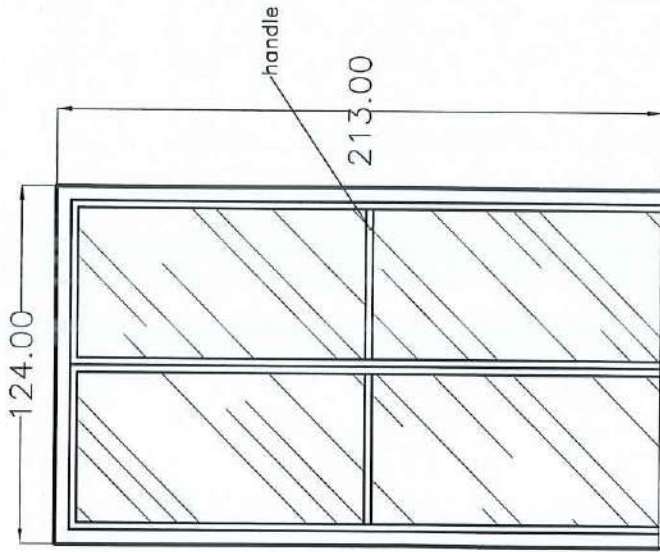

PCAF White Double Swing Door
 6mm thk Clear Glass
 2"x4" PCAF White Jamb
 complete w/ accessories
 1 SET
 LIBRARY

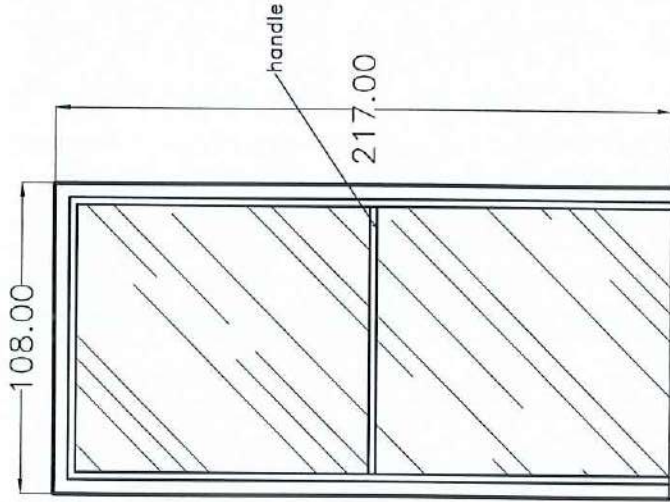

PCAF White Single Swing Door
 6mm thk Clear Glass
 2"x4" PCAF White Jamb
 complete w/ accessories
 1 SET
 ROOM 301 DOOR 2

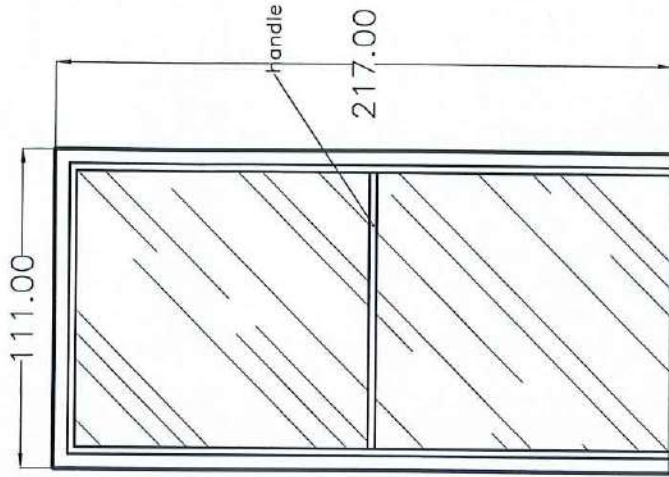

PCAF White Single Swing Door
 6mm thk Clear Glass
 2"x4" PCAF White Jamb
 complete w/ accessories
 1 SET
 ROOM 201 DOOR 2

| | | | | | | |
|--|---|--|---|---|-----------------|----------------|
| PROJECT TITLE FABRICATION AND INSTALLATION OF ALUMINUM SWING DOOR FOR MAIN BLDG OF USU FOLLLO CAMPUS ADDRESS: 800 FOLLLO CAMPUS FOLLLO, UTAH | PREPARED BY: ENGR. RONALDO SAN JOSE TRIAL PROJECTS, INC. AND FACILITIES | REVIEWED BY: <i>[Signature]</i> ENGR. MELVIN MANIPANGAN DIRECTOR, PLANNING AND FACILITIES DEVELOPMENT (PFD) | RECOMMENDING APPROVAL: <i>[Signature]</i> DR. FREDERICK T. VILLA VP, PLANNING AND FACILITIES DEVELOPMENT (PFD) | APPROVED BY: <i>[Signature]</i> DR. DORACIE B. ZOLETE-MANITES UNIVERSITY PRESIDENT | SHEET CONTENTS: | SHEET NO. 2 |
| | | | | | | |



REPUBLIC OF THE PHILIPPINES
SOUTHERN LUZON STATE UNIVERSITY
PHYSICAL PLANT AND FACILITIES



11

| | |
|-------------------------|--|
| PROJECT TITLE: | Fabrication and Installation of 12 sets of Sliding Window at Senior High School Bldg |
| PROJECT LOCATION: | SLSU-Main Campus, Lucban, Quezon |
| OWNER: | Southern Luzon State University |
| MODE OF IMPLEMENTATION: | by Contract |
| DURATION: | 10 working days for 2 Aluminum Installers |

SUMMARY

| ITEM | DESCRIPTION | MATERIALS COST | LABOR AND EQUIPMENT COST | TOTAL COST |
|---|-------------|----------------|--------------------------|------------|
| I | Windows | | | |
| TOTAL ESTIMATED DIRECT COST | | | | - |
| OVERHEAD, CONTINGENCIES AND MISC. (OCM) | | | | - |
| CONTRACTOR'S PROFIT | | | | - |
| VALUE ADDED TAX (VAT) | | | | - |
| TOTAL ESTIMATED PROJECT COST | | | | - |

REPUBLIC OF THE PHILIPPINES
SOUTHERN LUZON STATE UNIVERSITY
PHYSICAL PLANT AND FACILITIES

| | |
|-------------------------|--|
| PROJECT TITLE: | Fabrication and Installation of 12 sets of Sliding Window at Senior High School Bldg |
| PROJECT LOCATION: | SLSU Tayabas Campus, Tayabas City, Quezon |
| OWNER: | Southern Luzon State University |
| MODE OF IMPLEMENTATION: | by Contract |
| DURATION: | 10 working days for 2 Aluminum Installers |

BILL OF MATERIALS

| ITEM | DESCRIPTION | Qty | Unit | Direct Cost | Total Materials Cost |
|------------------------------------|--|-----|------|-------------|----------------------|
| I. Glass and Aluminum Works | | | | | |
| 1 | 4-Panel Aluminum Powder Coated White Frame Sliding Window with 6mm thk Clear Glass complete with accessories (See attached drawing for measurement details and Location) | 12 | set | | |
| SUB-TOTAL | | | | | - |



Republic of the Philippines
Southern Luzon State University
PHYSICAL PLANT AND FACILITIES

Project: Repair, Fabrication and Installation of 6 sets Sliding Window at Senior High School Bldg

Location: SLSU Main Campus, Lucban, Quezon

Implementation: by Contract

Duration: 10 Working days for 2 Aluminum Installers

SCOPE OF WORKS

I. Windows

- a. Fabricate and Install 4-Panel Aluminum Powder Coated White Frame Sliding Window with 6mm thk Clear Glass complete with accessories

PREPARED BY:

RONELITO O. SAN JOSE, PME
Head, Physical Plant and Facilities

RECOMMENDING APPROVAL:



DR. FREDERICK T. VILLA
VP, Administration and Financial Affairs

REVIEWED BY:

ENGR. MELVIN A. MAKIPAGAY
Director, Planning and Development Office
(Infrastructure)

APPROVED BY:


DR. DORACIE B. ZOLETA-NANTES
University President

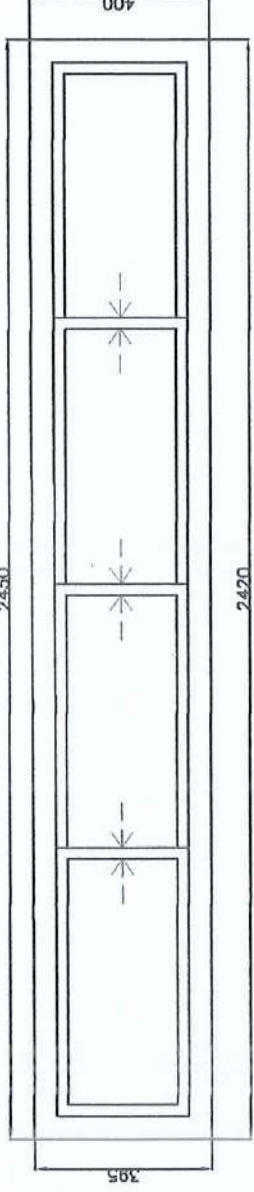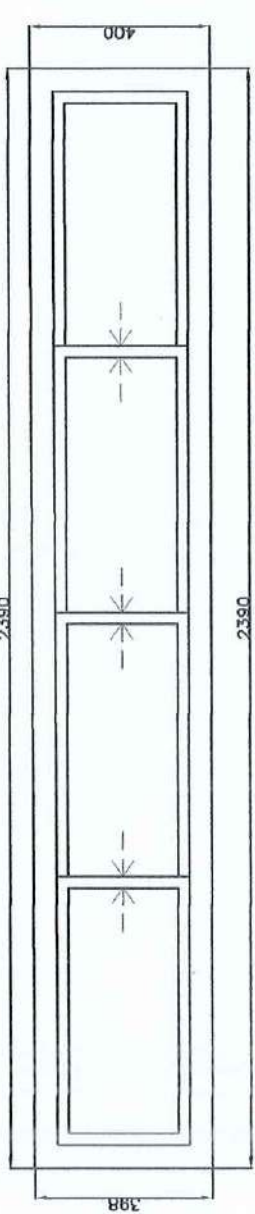

12-COURTESY
GROUND FLOOR

4 - PANEL ALUMINUM SLIDING GLASS WINDOW


| | | | | | |
|---|--|---|---|--|--|
| <p>PROJECT TITLE REPAIR, FABRICATION AND INSTALLATION OF ALUMINUM SLIDING GLASS WINDOW FOR OF BUILDINGS AND SCHOOL BUILDINGS</p> <p>ADDRESS: 2520 MAIN CAMPUS, BENTLEY BUILDING, DALLAS, TX 75201</p> | <p>PREPARED BY: ENGR. RONALDO O. SAN JOSE HEAD, PROJECT MGMT AND FINANCE</p> | <p>NOTED BY: <i>[Signature]</i> ENGR. MELVIN M. PIPERAY DIRECTOR, PLANNING AND REGULATORY AFFAIRS</p> | <p>RECOMMENDING APPROVAL: FREDERICK T. VILLA, DIT V.P. OF FINANCE AND FINANCIAL AFFAIRS</p> | <p>APPROVED BY: <i>[Signature]</i> DORACIE B. ZOLETANANTES, PHD UNIVERSITY PRESIDENT</p> | <p>SHEET CONTENTS: NAME / DATE / USE</p> |
|---|--|---|---|--|--|

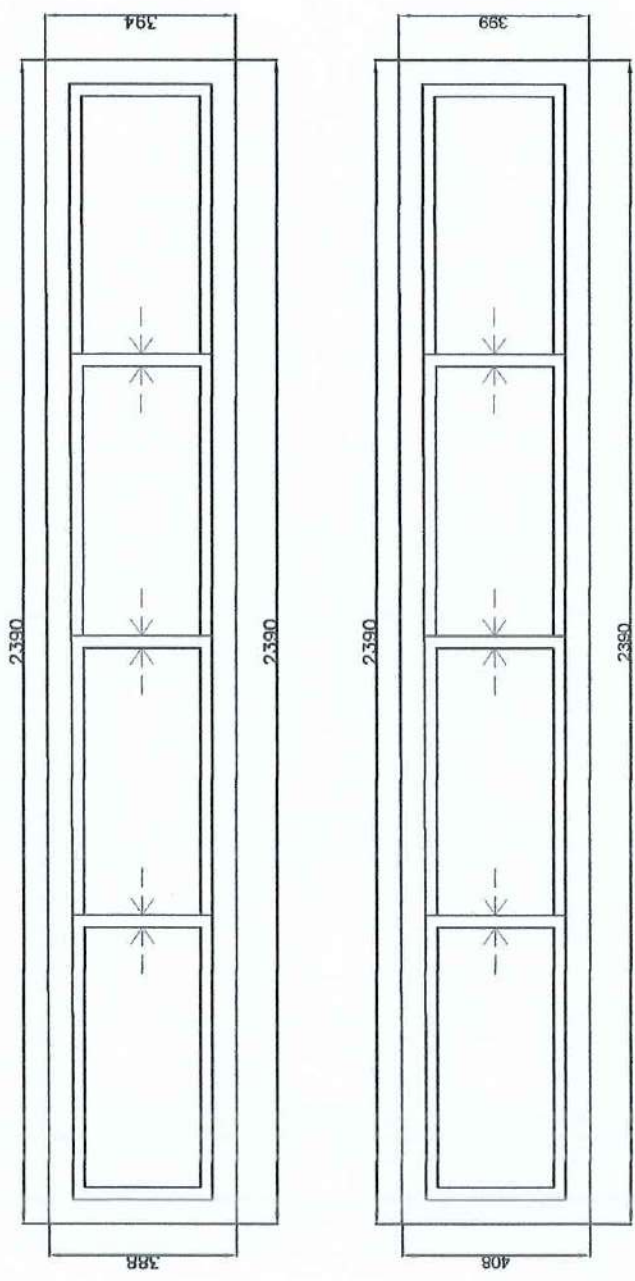

12-DIGNITY
GROUND FLOOR

4 - PANEL ALUMINUM SLIDING GLASS WINDOW



| | | | | | |
|--|--|---|---|---|---|
| <p>PROJECT TITLE REPAIR, FABRICATION AND INSTALLATION OF ALUMINUM AND GLASS PARTS - REPAIR OF BUILDINGS AND SCHOOL BUILDINGS ADDRESS: 2500 WINDY CAMPUS, BENTONVILLE, ARKANSAS</p> | <p>PREPARED BY: ENGR. RONALDO O. SAN JOSE Structural Engineering</p> | <p>NOTED BY: ENGR. MELVIN M. MADRIGAY Structural, Mechanical and Electrical Engineering</p> | <p>RECOMMENDING APPROVAL: FREDERICK J. VILLA, DIT VP. ARCHITECTURE AND STRUCTURAL ENGINEERING</p> | <p>APPROVED BY: DORACIEB. ZOLEYA-NANTES, PHD UNIVERSITY PROFESSOR</p> | <p>SHEET CONTENTS: NORMAL LINE SIZE: 1/8" MIN</p> |
|--|--|---|---|---|---|

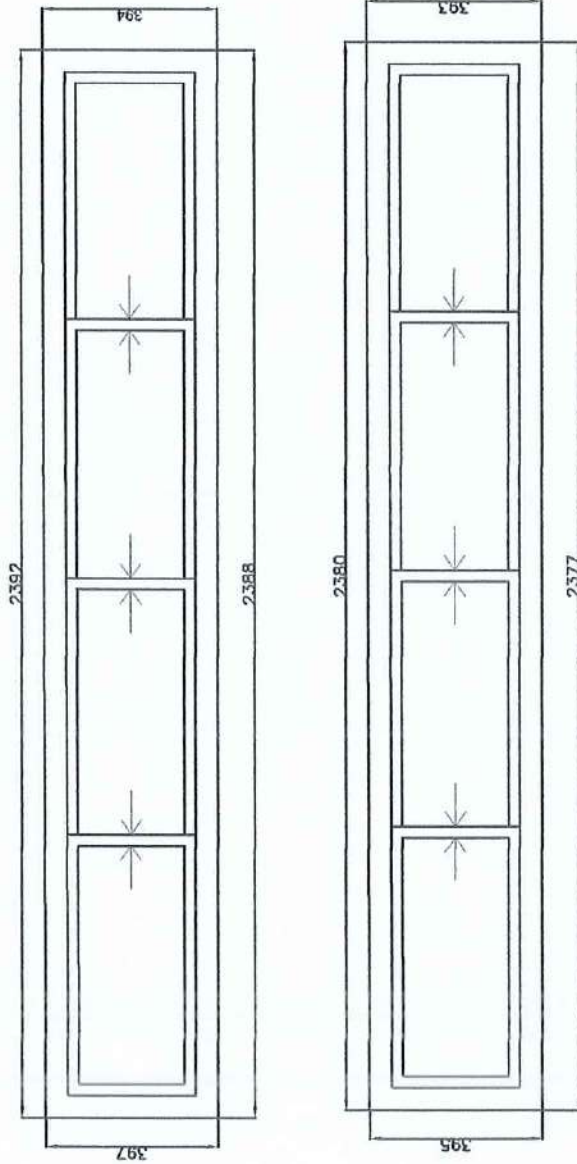

12-WISDOM
THIRD FLOOR

4 - PANEL ALUMINUM SLIDING GLASS WINDOW



| | | | | | |
|--|---|---|---|---|---|
| PROJECT TITLE REPAIR, FABRICATION AND INSTALLATION OF ALUMINUM SLIDING GLASS WINDOW ON BUILDINGS AND SCHOOL BUILDINGS OFFICE: BUILDING DAMAGE REPAIR ALUMINUM DIVISION 02520 | PREPARED BY: ENGR. ROBERTO G. SANTIAGO ENGR. MARIO M. SANTIAGO ENGR. MARIO M. SANTIAGO | NOTED BY: ENGR. MARIO M. SANTIAGO ENGR. MARIO M. SANTIAGO | RECOMMENDING APPROVAL: FREDERICK T. VILLA, DIT SVP, COLLEGE AND FINANCIAL AFFAIRS | APPROVED BY:  DORACIE B. ZOLET-ANANES, PHD UNIVERSITY PRESIDENT | SHEET CONTENTS: UNIVERSITY PRESIDENT |
|--|---|---|---|---|---|

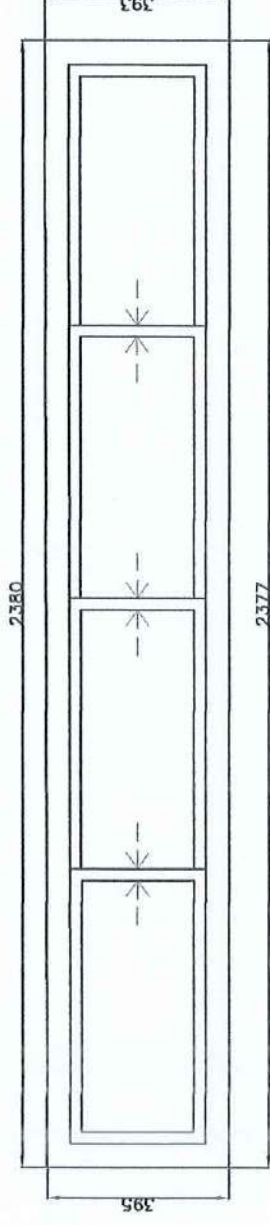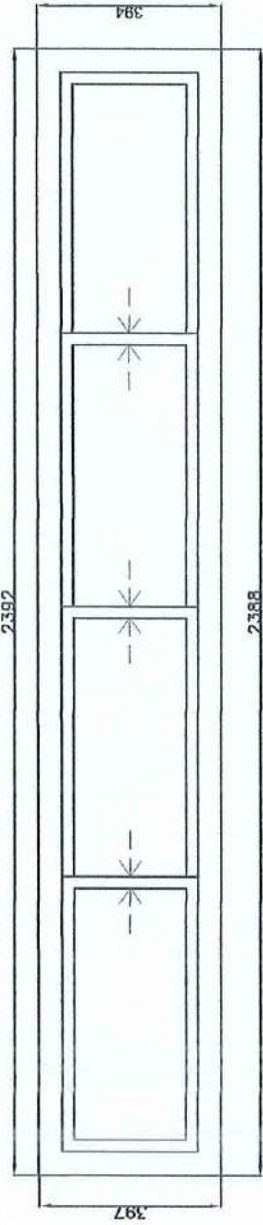

12-FAITH
SECOND FLOOR

4 - PANEL ALUMINUM SLIDING GLASS WINDOW



| | | | | | |
|--|--|--|--|---|--|
| <p>PROJECT TITLE REPAIR, FABRICATION AND INSTALLATION OF ALUMINUM AND GLASS FIXTURES - REPAIR OF BUILDINGS AND SCHOOL BUILDINGS</p> <p><small>ADDRESS: 2500 SANTA LAMPAS, BENTONVILLE, ARKANSAS 72716</small></p> | <p>PREPARED BY: ENGR. RONALDO D. SAN JOSÉ <small>REGISTERED PROFESSIONAL ENGINEER IN MECHANICAL ENGINEERING</small></p> | <p>NOTED BY: ENGR. MELVIN M. GONZALES <small>REGISTERED PROFESSIONAL ENGINEER IN MECHANICAL ENGINEERING</small></p> | <p>RECOMMENDING APPROVAL: FREDERICK ST. VILLA, DIT <small>VP. DESIGN, ARCHITECT AND FINANCIAL AFFAIRS</small></p> | <p>APPROVED BY: DORACIEB ZOLETE-NAJATES, PHD <small>UNIVERSITY PRESIDENT</small></p> | <p>SHEET CONTENTS: UNIVERSITY PROJECT</p> |
|--|--|--|--|---|--|

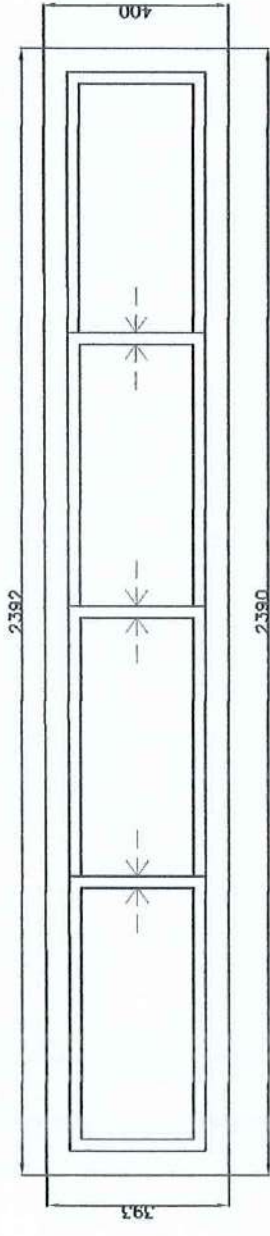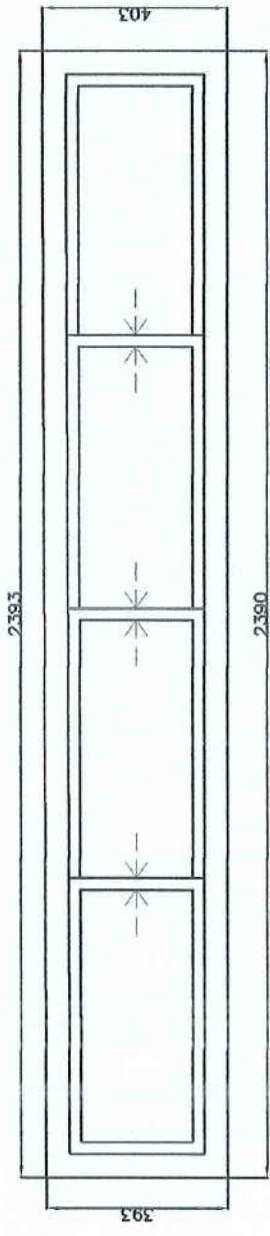

12 - PERSISTENCE
SECOND FLOOR

4 - PANEL ALUMINUM SLIDING GLASS WINDOW

| | | | | |
|---|--|--|---|---|
| <p>PROJECT TITLE REPAIR, FABRICATION AND INSTALLATION OF ALUMINUM AND GLASS FIXTURES - REPAIR OF BUILDINGS AND SCHOOL BUILDINGS</p> <p>DATE: 03-18-2019 SCALE: 1/8" = 1'-0"</p> | <p>NOTED BY: ENGR. RONALDO S. SANABRIA FIELD PROJECT MANAGER</p> | <p>RECOMMENDING APPROVAL: ENGR. FREDERICK A. VILLA, DIT S.P. PROJECT MANAGER</p> | <p>APPROVED BY: DORACIE B. ZOLETANANTES, PHD UNIVERSITY PRESIDENT</p> | <p>SHEET CONTENTS: NO. NAME, LINE, DATE, WORK</p> |
|---|--|--|---|---|

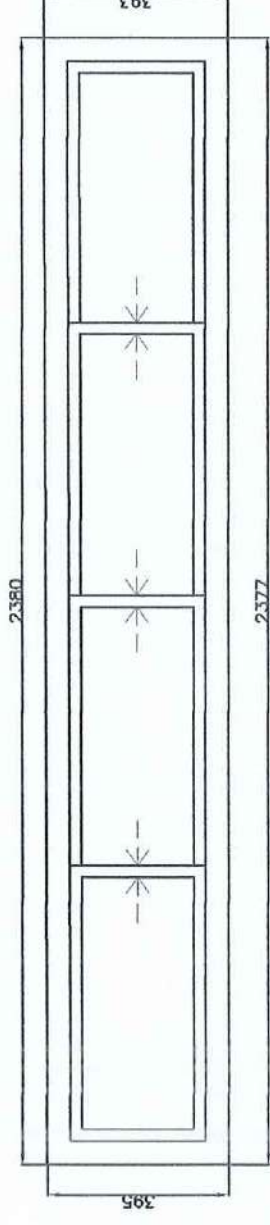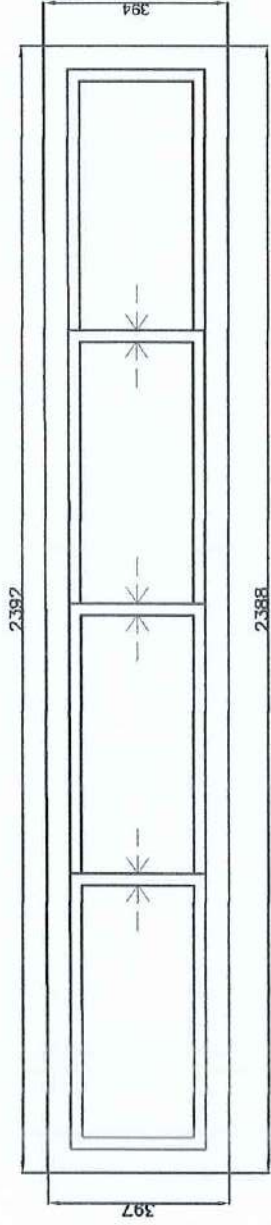

MUSIC ROOM
THIRD FLOOR

4 - PANEL ALUMINUM SLIDING GLASS WINDOW

| | | | | | |
|--|--|---|---|--|--|
| <p>PROJECT TITLE REPAIR, FABRICATION AND INSTALLATION OF ALUMINUM AND GLASS PARTIAL-HEIGHT OF BUILDINGS AND SCHOOL BUILDINGS</p> <p>ADDRESS: 3500 UNIVERSITY CAMPUS, UNIVERSITY OF CALIFORNIA, SAN DIEGO</p> | <p>PREPARED BY: ENGR. RONALDO C. SAN JOSE rjs@ucsd.edu</p> | <p>NOTED BY: ENGR. MELVIN A. MARQUEZ melmarque@ucsd.edu</p> | <p>RECOMMENDING APPROVAL: FREDERICK VILLA, DIT VP, ADMINISTRATION & FINANCIAL AFFAIRS</p> | <p>APPROVED BY: DORACIE B. ZOLETA-NANTES, PHD UNIVERSITY PRESIDENT</p> | <p>SHEET CONTENTS: NUMBER, DATE, SCALE</p> |
|--|--|---|---|--|--|



REPUBLIC OF THE PHILIPPINES
SOUTHERN LUZON STATE UNIVERSITY
PHYSICAL PLANT AND FACILITIES



| | |
|-------------------------|--|
| PROJECT TITLE: | Repair and Improvement of Record's Room in Admin Bldg of SLSU Tiaong |
| PROJECT LOCATION: | SLSU-Tiaong Campus, Tiaong, Quezon |
| OWNER: | Southern Luzon State University |
| MODE OF IMPLEMENTATION: | by Administration / by Contract |
| DURATION: | 5 working days 2 Glass Installer |


| SUMMARY | | | | | | |
|-------------------------------------|-------------|-----------------------|-------------------------|---------------------|------------------------|-------|
| ITEM | DESCRIPTION | MATERIALS DIRECT COST | INDIRECT COST (OCM/VAT) | MATERIALS UNIT COST | LABOR & EQUIPMENT COST | TOTAL |
| 1 | Window | - | - | - | - | - |
| TOTAL ESTIMATED PROJECT COST | | | | | | - |

REPUBLIC OF THE PHILIPPINES
SOUTHERN LUZON STATE UNIVERSITY
PHYSICAL PLANT AND FACILITIES

| | |
|-------------------------|--|
| PROJECT TITLE: | Repair and Improvement of Record's Room in Admin Bldg of SLSU Tiaong |
| PROJECT LOCATION: | SLSU-Tiaong Campus, Tiaong, Quezon |
| OWNER: | Southern Luzon State University |
| MODE OF IMPLEMENTATION: | by Administration / by Contract |
| DURATION: | 5 working days 2 Glass Installer |

BILL OF MATERIALS

| ITEM | DESCRIPTION | Qty | Unit | Materials Direct Cost | Total Materials Direct Cost | Indirect Cost (VAT/OCM) | TOTAL UNIT COST |
|------------------|--|-----|------|-----------------------|-----------------------------|-------------------------|-----------------|
| I. Window | | | | | | | |
| 1 | Fabrication and Installation of Aluminum White Framed 5- Panel Sliding Window (2.3m x 1.52m) complete with accessories | 2 | sets | | | - | - |
| SUB-TOTAL | | | | - | - | - | - |

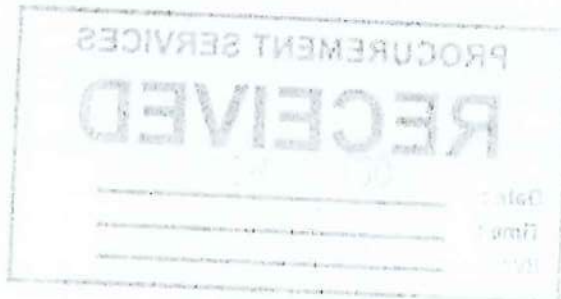



Project: Repair and Improvement of Record's Room in Admin Bldg of SLSU Tiaong
Location: SLSU Tiaong Campus, Tiaong, Quezon
Implementation: by Contract
Duration: 5 working days for 2 Glass Installer

Southern Luzon State University
 Office of the President
 Received

Date: 9/29/20
 Time: 9:00 AM
 Received by: [Signature]

SCOPE OF WORKS


- I. **Windows (by Contract)**
- Dismantling of the old window installed
 - Fabrication of window as stated on the drawing plan.
 - Installation of the New Window

PREPARED BY:
 [Signature]
RONELITO O. SAN JOSE, PME
 Head, Physical Plant and Facilities

REVIEWED BY:
 [Signature]
ENGR. MELVIN A. MAKIPAGAY
 Director, Planning and Development Office
 (Infrastructure)

RECOMMENDING APPROVAL:
 [Signature]
DR. FREDERICK T. VILLA
 VP, Administration and Financial Affairs

APPROVED BY:
 [Signature]
DR. DORACIE B. ZOLETA-NANTES
 University President

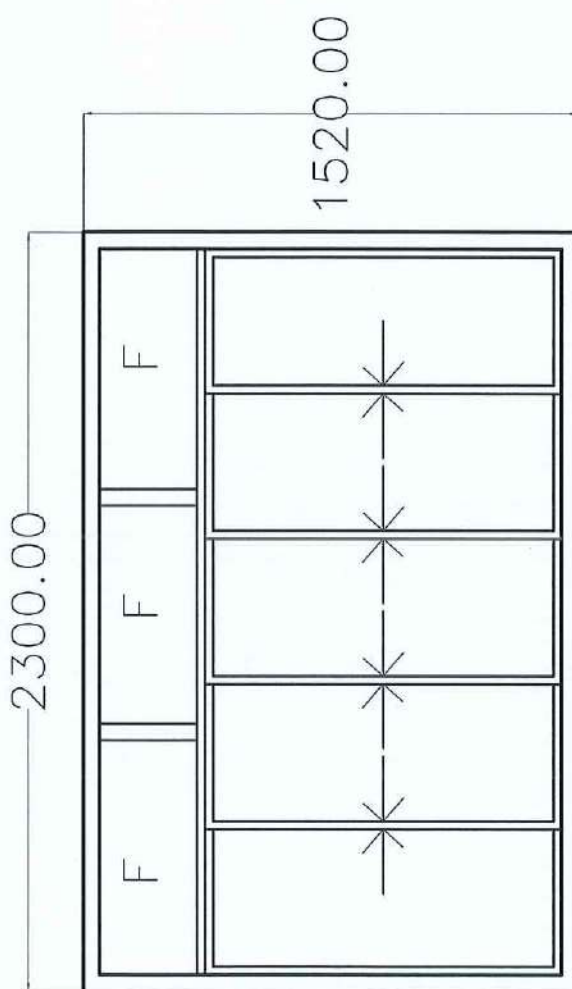

SLIDING WINDOW W/ PCAF WHITE AND
6MM THK GLASS
2SETS

MEASUREMENS ARE IN MILLIMETER

| | | | | | | | | | | | | | |
|---------------|---|--|--------------|--|--------------|---|------------------------|---|--------------|---|-----------|-----------------|-----|
| PROJECT TITLE | Regular and Improvement of Record's Room in Admin Bldg of SLSU Taclog | ADDRESS: SLSU TACLOG CAMPUS, TAGBILARAN CITY, CEBU | PREPARED BY: | ENGR. RONELITO O. SAN JOSE SEAL, PROFESSIONAL ENGINEER AND REGISTERED ARCHITECT | REVIEWED BY: | ENGR. MELVINA MANTAPAGAY DIRECTOR, PLANNING AND CONSTRUCTION OFFICE, SLSU TACLOG | RECOMMENDING APPROVAL: | DR. PRIGERICK T. VILLA ACADEMIC DEPARTMENT HEAD, SLSU TACLOG | APPROVED BY: | DR. DORACIE B. ZOLETA-NAWES UNIVERSITY PRESIDENT | SHEET NO. | SHEET CONTENTS: | A-1 |
|---------------|---|--|--------------|--|--------------|---|------------------------|---|--------------|---|-----------|-----------------|-----|



REPUBLIC OF THE PHILIPPINES
SOUTHERN LUZON STATE UNIVERSITY
PHYSICAL PLANT AND FACILITIES



| | |
|-------------------------|---|
| PROJECT TITLE: | Repair, Fabrication and Installation of Windows at SLSU Gumaca Campus |
| PROJECT LOCATION: | Main Bldg, SLSU Gumaca Campus, Gumaca, Quezon |
| OWNER: | Southern Luzon State University |
| MODE OF IMPLEMENTATION: | by Contract |
| DURATION: | 10 calendar days for 3 workers |

| | | | | |
|----------------|--|--|--|--|
| SUMMARY | | | | |
|----------------|--|--|--|--|

| ITEM | DESCRIPTION | MATERIALS COST | LABOR AND EQUIPMENT COST | TOTAL COST |
|--|---------------------|----------------|--------------------------|------------|
| I | Demolition/Clearing | - | - | - |
| II | Windows | - | - | - |
| TOTAL ESTIMATED DIRECT COST | | | | - |
| OVERHEAD, CONTINGENCIES AND MISC. (OCM) | | | | - |
| CONTRACTOR'S PROFIT | | | | - |
| VALUE ADDED TAX (VAT) | | | | - |
| TOTAL ESTIMATED PROJECT COST | | | | - |

REPUBLIC OF THE PHILIPPINES
SOUTHERN LUZON STATE UNIVERSITY
PHYSICAL PLANT AND FACILITIES

| | |
|-------------------------|---|
| PROJECT TITLE: | Repair, Fabrication and Installation of Windows of SLSU Gumaca Campus |
| PROJECT LOCATION: | Main Bldg, SLSU Gumaca Campus, Gumaca, Quezon |
| OWNER: | Southern Luzon State University |
| MODE OF IMPLEMENTATION: | by Contract |
| DURATION: | 10 calendar days for 3 workers |

BILL OF MATERIALS

| ITEM | DESCRIPTION | Qty | Unit | Direct Cost | Total Materials Cost |
|-------------------|---|-----|------|-------------|----------------------|
| I. Windows | | | | | |
| 1 | Fabrication & Installation of Jalouplus Windows with Aluminum Frame Powder Coated White 2"x4" (6mm thk Clear Glass) including 6mm fixed Clear Glass (4Panel) (See Plan Attachment for Details) | 8 | set | | |
| SUB-TOTAL | | | | | - |



Project: Repair, Fabrication and Installation of Windows at SLSU Gumaca Campus
Location: Main Bldg, SLSU Gumaca Campus, Gumaca, Quezon
Implementation: by Contract
Duration: 10 Calendar Days for 3 Workers

SCOPE OF WORKS

I. Demolition/Clearing

- The contractor must be responsible for the removal/ demolition of old window installed at the site.
- The contractor must be responsible for the safety of the students and staffs within the area.
- SLSU will be responsible for the disposal/inspection of the removed materials.

II. Windows

- The contractor must fabricate and install the window according to the proposed plan within the specified time frame.
- The contractor must be responsible for the safety of the students and staffs within the area.

PREPARED BY:

RONELITO O. SAN JOSE, PME
Head, Physical Plant and Facilities

RECOMMENDING APPROVAL:


DR. FREDERICK T. VILLA
VP, Administration and Financial Affairs

REVIEWED BY:

ENGR. MELVIN A. MAKIPAGAY
Director, Planning and Development Office
(Infrastructure)

APPROVED BY:

DR. DORACIE BI ZOLETA-NANTES
University President

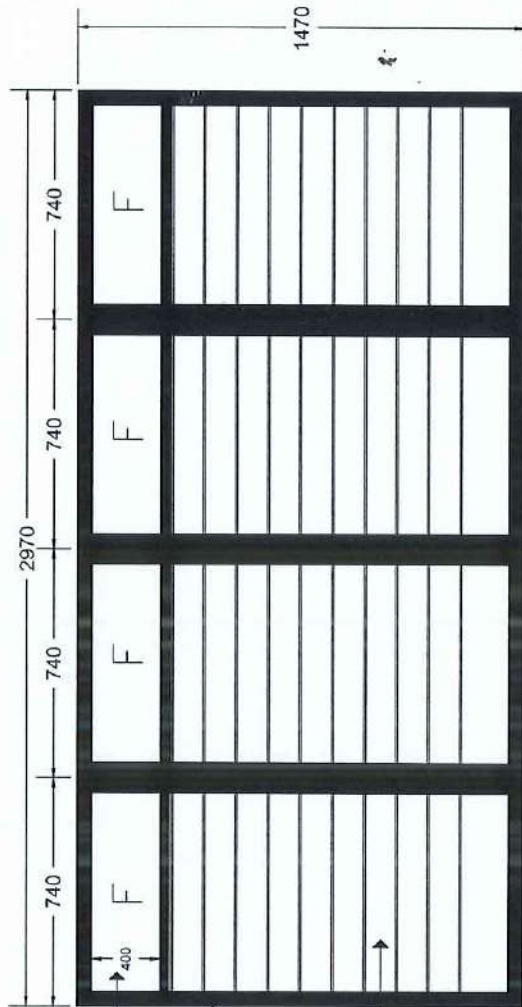

FIXED CLEAR GLASS WINDOW



ALUMINUM JALOUSIS FRAME
 COLOR: WHITE
 SIZE: 2'x4'

6MM THK JALOUSIS
 LOUVER CLEAR
 GLASS WINDOW

| | | | | | | | | | | | |
|---------------|--|-----------------|--|-------------|---|-----------------------|---|-------------|--|-----------|-----|
| PROJECT TITLE | FABRICATION AND INSTALLATION OF JALOUSIS WINDOW AT OLD SLSM CAMPUS | PREPARED BY | ENGR. ROBERTO LO SAN JESUS SAS INCORPORATED | REVIEWED BY | ENGR. MELVA M. SANCHEZ ARCHITECTURAL INTERIORS INC. (AIA) REGISTERED | RECOMMENDING APPROVAL | DR. FREDERICK T. VILLA VP. CONSULTING AND TRAINING AFFAIRS | APPROVED BY | DR. DORACIE B. ZOLETA-NANTES DIRECTOR PRESENT | SHEET NO. | A-1 |
| | | SHEET CONTENTS: | | | | | | | | | |

| WINDOW SCHEDULES | |
|------------------|---------------------------------|
| Full Element ID | WD - 009 |
| Opening Name | Horizontal Multi-Sash Window 19 |
| Quantity | 8 sets |
| W x H Size | 2.97x1.47 |
| Head height | 2.37 |

| | |
|--|--|
| | <p>VIEW FROM SIDE OPPOSITE TO OPENING SIDE</p> <p>HEAD SLUR 0.05 INCH ALUMINUM ANGLE COLOR: WHITE SIZE: 3/4"</p> <p>SEE THE ALUMINUM CLAD WINDOW</p> |
|--|--|

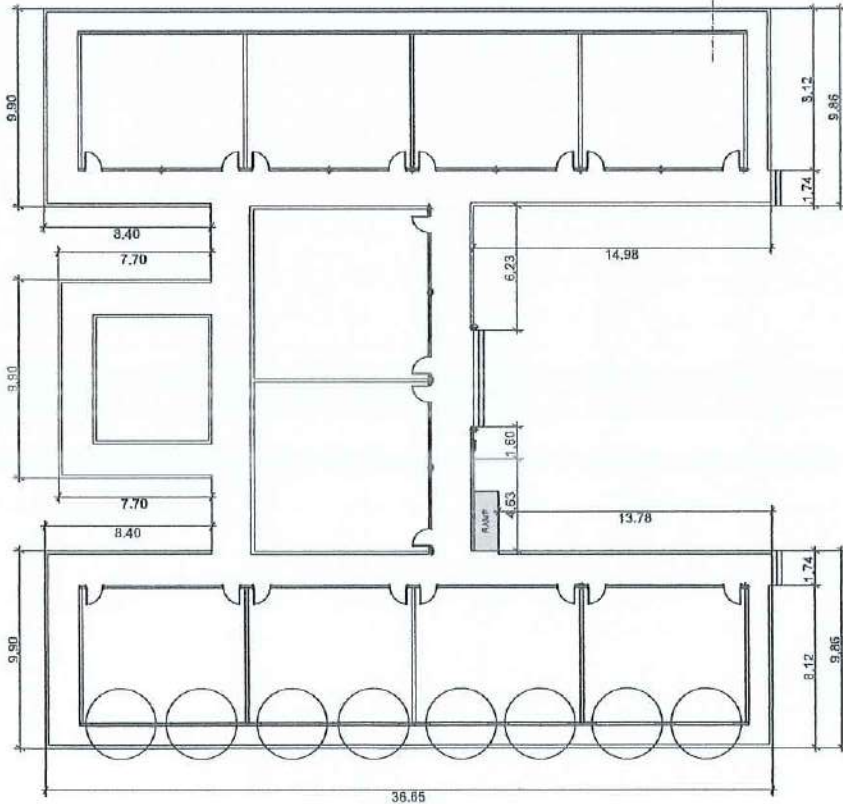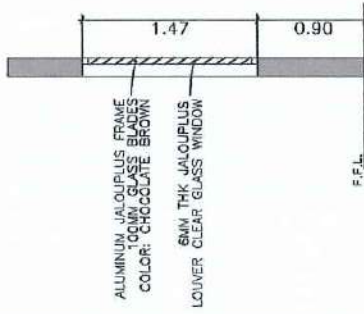

GROUND FLOOR LINE

| PROJECT TITLE | PREPARED BY | REVIEWED BY | RECOMMENDING APPROVAL | APPROVED BY | SHEET CONTENTS | SHEET NO. |
|---|-----------------------------|-----------------------------|---------------------------|---------------------------------|-----------------------------------|-----------|
| PROJECT: ESTABLISHMENT OF A JACUZZI AND SPA AT OLD SIDA DAMBA PHASE: ESTABLISHMENT OF SPA | R. POHLEY / C. SAN JUAN | R. POHLEY / C. SAN JUAN | DR. FREDERIK T. VILLA | DR. DORACIE B. ZOLETANANIES | SHEET NO. 01 OF 02 02 OF 02 | A-2 |



REPUBLIC OF THE PHILIPPINES
SOUTHERN LUZON STATE UNIVERSITY
PHYSICAL PLANT AND FACILITIES



| | |
|-------------------------|--|
| PROJECT TITLE: | Repair, Fabrication and Installation of Aluminum Swing Door for Tayabas Campus |
| PROJECT LOCATION: | SLSU Tayabas Campus, Tayabas City, Quezon |
| OWNER: | Southern Luzon State University |
| MODE OF IMPLEMENTATION: | by Contract |
| DURATION: | 3 working days for 2 Aluminum Installers |

SUMMARY


| ITEM | DESCRIPTION | MATERIALS COST | LABOR AND EQUIPMENT COST | TOTAL COST |
|--|--------------------------|----------------|--------------------------|------------|
| 1 | Glass and Aluminum Works | - | - | - |
| <i>TOTAL ESTIMATED DIRECT COST</i> | | | | - |
| <i>OVERHEAD, CONTINGENCIES AND MISC. (OCM)</i> | | | | - |
| <i>CONTRACTOR'S PROFIT</i> | | | | - |
| <i>VALUE ADDED TAX (VAT)</i> | | | | - |
| TOTAL ESTIMATED PROJECT COST | | | | - |

REPUBLIC OF THE PHILIPPINES
SOUTHERN LUZON STATE UNIVERSITY
PHYSICAL PLANT AND FACILITIES

| | |
|-------------------------|--|
| PROJECT TITLE: | Repair, Fabrication and Installation of Aluminum Swing Door for Tayabas Campus |
| PROJECT LOCATION: | SLSU Tayabas Campus, Tayabas City, Quezon |
| OWNER: | Southern Luzon State University |
| MODE OF IMPLEMENTATION: | by Contract |
| DURATION: | 3 working days for 2 Aluminum Installers |

BILL OF MATERIALS

| ITEM | DESCRIPTION | Qty | Unit | Direct Cost | Total Materials Cost |
|------------------------------------|---|-----|------|-------------|----------------------|
| I. Glass and Aluminum Works | | | | | |
| 1 | Aluminum Swing Door with 6mm th Clear Glass (w/ Frosted Glass Slickers) and a 2"x4" PCAF White Door Jamb suited for the Swing Door; complete w/ handle and accessories (see attached drawing for details) | 4 | set | | |
| SUB-TOTAL | | | | | - |

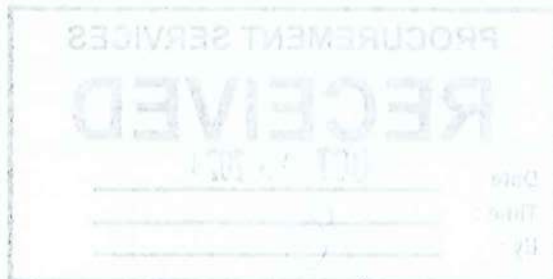



Republic of the Philippines
Southern Luzon State University
PHYSICAL PLANT AND FACILITIES



Project: Repair, Fabrication and Installation of Aluminum Swing Door and Wooden Flush Door for Tayabas Campus

Location: SLSU Tayabas Campus, Tayabas City, Quezon

Implementation: by Administration / by Contract

Duration: 7 Working Days for 4 Workers

SCOPE OF WORKS

I. Glass and Aluminum Works (by Contract)

- Fabrication and Installation of Aluminum Swing Door as per attached Drawing

II. Carpentry Works

- The contractor must supply the materials as indicated on the estimate and Purchase Order
- Physical Plant and Facilities Office must supply the labor for the intended activity

III. Windows

- The contractor must supply the materials as indicated on the estimate and Purchase Order
- Physical Plant and Facilities Office must supply the labor for the intended activity

PREPARED BY:

RONELITO O. SAN JOSE, PME
Head, Physical Plant and Facilities

REVIEWED BY:

ENGR. MELVIN A. MAKIPAGAY
Director, Planning and Development Office
(Infrastructure)

RECOMMENDING APPROVAL:

DR. FREDERICK T. VILLA
VP, Administration and Financial Affairs

APPROVED BY:

DR. DORACIE B. ZOLETA-NANTES
University President



Project: Repair, Fabrication and Installation of Aluminum Swing Door for Tayabas Campus

Location: SLSU Tayabas Campus, Tayabas City, Quezon

Implementation: by Contract

Duration: 3 Working Days for 2 Aluminum installers

SCOPE OF WORKS

I. Glass and Aluminum Works (by Contract)

- Fabrication and Installation of Aluminum Swing Door as per attached Drawing

PREPARED BY:

RONELITO O. SAN JOSE, PME
Head, Physical Plant and Facilities

REVIEWED BY:


ENGR. MELVIN A. MAKIPAGAY
Director, Planning and Development Office
(Infrastructure)

RECOMMENDING APPROVAL:


DR. FREDERICK T. VILLA
VP, Administration and Financial Affairs

APPROVED BY:

DR. DORACIE B. TOLETA-NANTES
University President

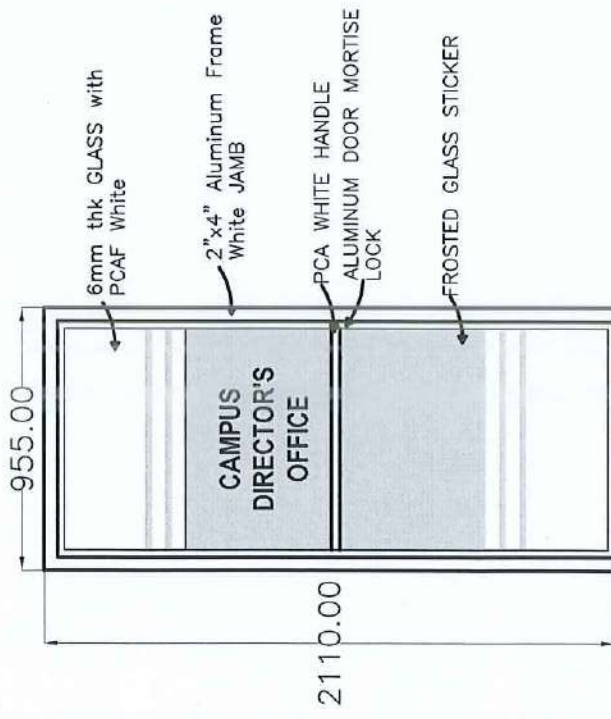


CAMPUS DIRECTOR'S OFFICE

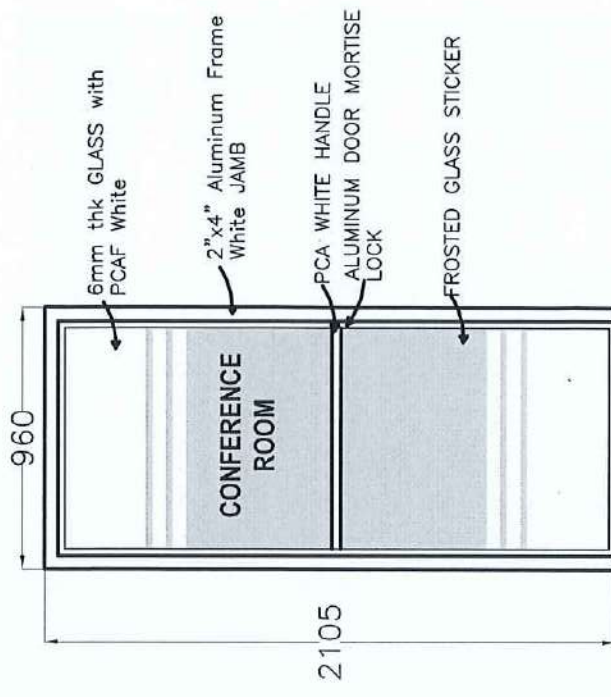


CONFERENCE ROOM

Note: Dimensions are in mm.

| | | |
|---------------|--|---|
| PROJECT TITLE | REPAIR, FABRICATION AND INSTALLATION OF ALUMINUM AND GLASS DOORS | ADDRESS: 3401 N. HALLS CAMPUS, TAMPAH CITY, FLORIDA |
| PREPARED BY: | ENGR. RONALDO O. SAN JOSE REAL PROPERTY, PLANT AND FACILITIES | |
| REVIEWED BY: | ENGR. MELVIN A. MONTAGNA DIRECTOR, PLANNING AND DEVELOPMENT OFFICE, STATE COLLEGE | |
| PROJECT TITLE | FREDERICK T. VILLA, DIT VP, PARTICIPATING AND FINANCIAL AFFAIRS | |
| APPROVED BY: | <i>[Signature]</i> DOUGLAS B. ZOETA-VANATES, PHD UNIVERSITY PRESIDENT | |
| | ALUMINUM DOOR | 1 |

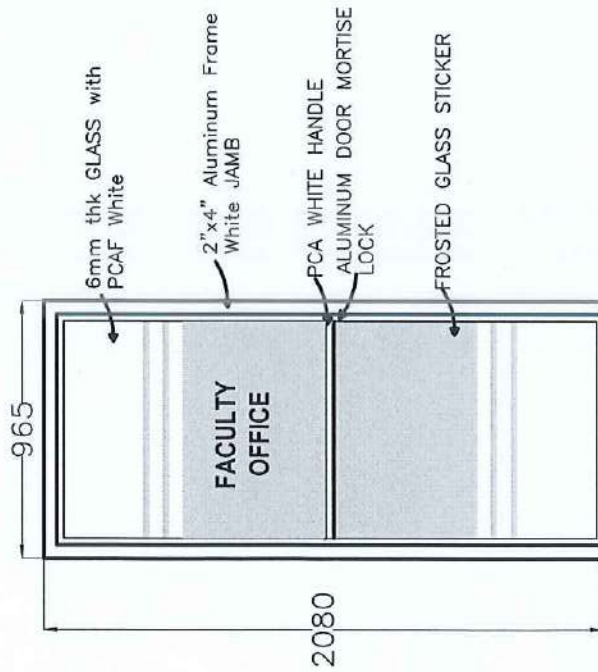

FACULTY OFFICE
DOOR 1

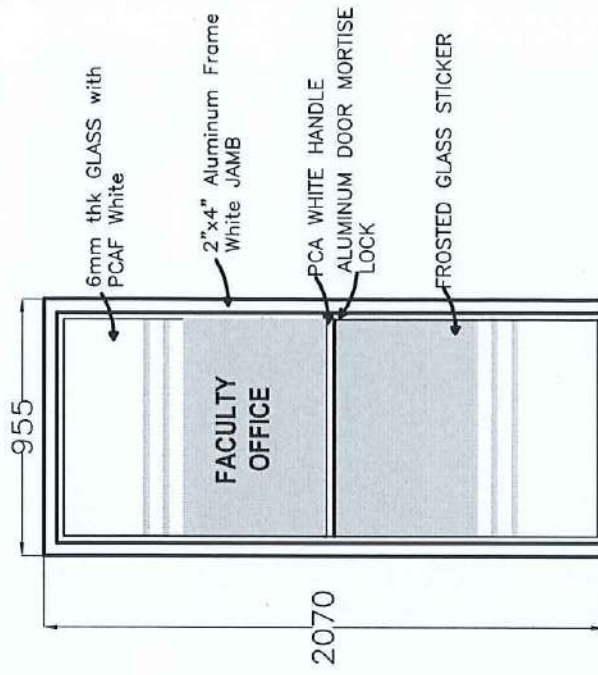

FACULTY OFFICE
DOOR 2

Notes: Dimensions are in mm.

| | | | | | | | |
|---------------|--|---------------|---------------------------|---------------|---------------------------|--------------|---------------|
| PROJECT TITLE | REPAIR, FABRICATION AND INSTALLATION OF ALUMINUM AND GLASS DOORS | PREPARED BY: | ENGR. RONALDO O. SAN JOSÉ | REVIEWED BY: | ENGR. MELVIN A. MANSAPANG | APPROVED BY: | LUMINA BUREAU |
| PROJECT TITLE | FACULTY OFFICE DOOR 1 | PROJECT TITLE | FREDERICK T. VILLA, DIT | PROJECT TITLE | DOOR 2 | APPROVED BY: | LUMINA BUREAU |
| PROJECT TITLE | FACULTY OFFICE DOOR 1 | PROJECT TITLE | DOOR 2 | PROJECT TITLE | DOOR 2 | APPROVED BY: | LUMINA BUREAU |
| PROJECT TITLE | FACULTY OFFICE DOOR 1 | PROJECT TITLE | DOOR 2 | PROJECT TITLE | DOOR 2 | APPROVED BY: | LUMINA BUREAU |
| PROJECT TITLE | FACULTY OFFICE DOOR 1 | PROJECT TITLE | DOOR 2 | PROJECT TITLE | DOOR 2 | APPROVED BY: | LUMINA BUREAU |

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REPUBLIC OF THE PHILIPPINES
SOUTHERN LUZON STATE UNIVERSITY
PHYSICAL PLANT AND FACILITIES



| | |
|-------------------------|--|
| PROJECT TITLE: | Repair, Fabrication and Installation of Aluminum & Glass Double Swing Door for HR Office, Admin Bldg |
| PROJECT LOCATION: | SLSU Main Campus, Lucban, Quezon |
| OWNER: | Southern Luzon State University |
| MODE OF IMPLEMENTATION: | by Contract |
| DURATION: | 3 working days for 2 Aluminum Installers |

SUMMARY

| ITEM | DESCRIPTION | MATERIALS COST | LABOR AND EQUIPMENT COST | TOTAL COST |
|--|--------------------------|----------------|--------------------------|------------|
| I | Glass and Aluminum Works | - | - | - |
| <i>TOTAL ESTIMATED DIRECT COST</i> | | | | - |
| <i>OVERHEAD, CONTINGENCIES AND MISC. (OCM)</i> | | | | - |
| <i>CONTRACTOR'S PROFIT</i> | | | | - |
| <i>VALUE ADDED TAX (VAT)</i> | | | | - |
| <i>TOTAL ESTIMATED PROJECT COST</i> | | | | - |

REPUBLIC OF THE PHILIPPINES
SOUTHERN LUZON STATE UNIVERSITY
PHYSICAL PLANT AND FACILITIES

| | |
|-------------------------|--|
| PROJECT TITLE: | Repair, Fabrication and Installation of Aluminum & Glass Double Swing Door for HR Office, Admin Bldg |
| PROJECT LOCATION: | SLSU Main Campus, Lucban, Quezon |
| OWNER: | Southern Luzon State University |
| MODE OF IMPLEMENTATION: | by Contract |
| DURATION: | 3 working days for 2 Aluminum Installers |

BILL OF MATERIALS

| ITEM | DESCRIPTION | Qty | Unit | Direct Cost | Total Materials Cost |
|------|-------------|-----|------|-------------|----------------------|
|------|-------------|-----|------|-------------|----------------------|

I. Glass and Aluminum Works

| | | | | | |
|------------------|---|---|-----|--|---|
| 1 | Aluminum Double Swing Door with 6mm thk Clear Glass (w/ Frosted Glass Stickers) and a 2"x4" PCAF White Door Jamb suited for the Swing Door; complete w/ handle and accessories (see attached drawing for details) | 1 | set | | |
| SUB-TOTAL | | | | | - |



Project: Repair, Fabrication and Installation of Aluminum & Glass Double Swing Door
for HR Office, Admin Bldg

Location: SLSU Lucban Campus, Lucban, Quezon

Implementation: by Contract

Duration: 3 Working Days for 2 Aluminum Installers

SCOPE OF WORKS

I. Glass and Aluminum Works

- Fabrication and Installation of Aluminum Double Swing Door as per attached Drawing
- Materials are subject for approval before installation

PREPARED BY:

RONELITO O. SAN JOSE, PME
Head, Physical Plant and Facilities

REVIEWED BY:


ENGR. MELVIN A. MAKIPAGAY
Director, Planning and Development Office
(Infrastructure)

RECOMMENDING APPROVAL:

DR. FREDERICK T. VILLA
VP, Administration and Financial Affairs

APPROVED BY:

DR. DORACIE B. ZOLSTA-NANTES
University President

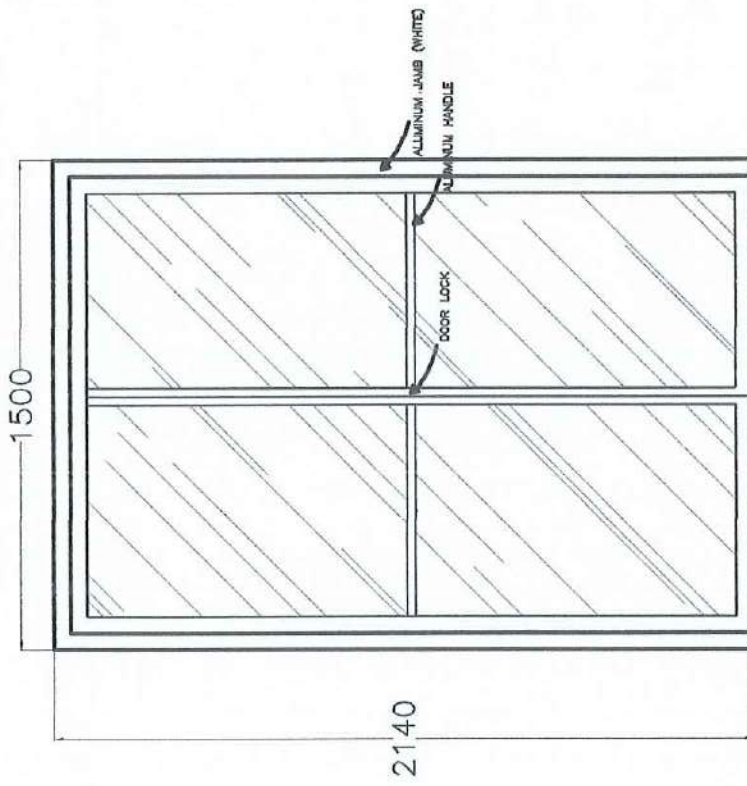

ALUMINUM DOUBLE SWING DOOR
HR OFFICE

| | | | | | | | | | |
|---------------|---|--------------|--|--------------|---|---------------|--|--------------|---|
| PROJECT TITLE | REPAIR, FABRICATION AND INSTALLATION OF ALUMINUM & GLASS DOUBLE SWING DOOR FOR HR OFFICE AT ADMIN BLDG ADDRESS: SLOAN CAMPUS, LUDOVICIANA | PREPARED BY: | ENGR. RONELITO O. SAN JOSE REG. PROFESSIONAL ENGINEER | REVIEWED BY: | ENGR. MELVIN M. MAGAY REGISTERED PROFESSIONAL ENGINEER | PROJECT TITLE | FREDERICK T. VILLA, DIT VP, ADMIN AND FINANCIAL AFFAIRS | APPROVED BY: | DORACIE B. ZOLETA-NANTES, PHD UNIVERSITY PRESIDENT |
|---------------|---|--------------|--|--------------|---|---------------|--|--------------|---|

16-17



REPUBLIC OF THE PHILIPPINES
SOUTHERN LUZON STATE UNIVERSITY
PHYSICAL PLANT AND FACILITIES



| | |
|-------------------------|--|
| PROJECT TITLE: | Repair, fabrication and Installation of Aluminum Sliding Door and Window of BAO at Ground Floor CABHA Bldg |
| PROJECT LOCATION: | CABHA Bldg, SLSU Main Campus, Lucban, Quezon |
| OWNER: | Southern Luzon State University |
| MODE OF IMPLEMENTATION: | by Contract |
| DURATION: | 10 calendar days for 2 Aluminum Installers |

| | | | | |
|----------------|--|--|--|--|
| SUMMARY | | | | |
|----------------|--|--|--|--|

| ITEM | DESCRIPTION | MATERIALS COST | LABOR AND EQUIPMENT COST | TOTAL COST |
|--|-------------|----------------|--------------------------|------------|
| I | Doors | - | - | - |
| II | Windows | - | - | - |
| <i>TOTAL ESTIMATED DIRECT COST</i> | | | | - |
| <i>OVERHEAD, CONTINGENCIES AND MISC. (OCM)</i> | | | | - |
| <i>CONTRACTOR'S PROFIT</i> | | | | - |
| <i>VALUE ADDED TAX (VAT)</i> | | | | - |
| TOTAL ESTIMATED PROJECT COST | | | | - |

16-17

REPUBLIC OF THE PHILIPPINES
SOUTHERN LUZON STATE UNIVERSITY
PHYSICAL PLANT AND FACILITIES

| | |
|-------------------------|--|
| PROJECT TITLE: | Repair, fabrication and Installation of Aluminum Sliding Door and Window of BAO at |
| PROJECT LOCATION: | CABHA Bldg, SLSU Main Campus, Lucban, Quezon |
| OWNER: | Southern Luzon State University |
| MODE OF IMPLEMENTATION: | by Contract |
| DURATION: | 10 calendar days for 2 Aluminum Installers |

BILL OF MATERIALS

| ITEM | DESCRIPTION | Qty | Unit | Direct Cost | Total Materials Cost |
|------|-------------|-----|------|-------------|----------------------|
|------|-------------|-----|------|-------------|----------------------|

I. Doors

| | | | | | |
|------------------|---|---|------|--|---|
| 1 | Fabrication & Installation of 2"x4" Heavy Duty Door Jamb (with Powder Coated Green Aluminum Frame) and a 4-Panel Aluminum Sliding Door with 6mm thk Clear Green Glass (with powder coated white Green Frame) Complete with accessories <i>(See attached drawing for details)</i> | 1 | sets | | |
| SUB-TOTAL | | | | | - |

II. Windows

| | | | | | |
|------------------|---|---|------|--|---|
| 1 | Fabrication & Installation of Aluminum Sliding Windows with Aluminum Frame Powder Coated Green (6mm thk Clear Glass) including 6mm fixed Clear Green Glass (2Panel) <i>(See Plan Attachment for Details)</i> | 6 | sets | | |
| SUB-TOTAL | | | | | - |



Project: Repair, fabrication and Installation of Aluminum Sliding Door and Window of BAO at Ground Floor CABHA Bldg

Location: SLSU Main Campus, Lucban, Quezon

Implementation: by Contract

Duration: 10 Working Days for 2 Aluminum Installers

SCOPE OF WORKS

I. Doors

- Measurement/ Verification of measurement of materials to be fabricated
- Fabrication of Aluminum Frame
- Installation of Fabricated materials complete with accessories
- This must include the existing sliding door.

II. Windows

- Measurement/ Verification of measurement of materials to be fabricated
- Fabrication of Aluminum Frame
- Contractor is advised to use the glass that will be cut from the existing window if possible.
- Installation of Fabricated materials complete with accessories

PREPARED BY:

RONELITO O. SAN JOSE, PME
Head, Physical Plant and Facilities

REVIEWED BY:


ENGR. MELVIN A. MAKIPAGAY
Director, Planning and Development Office
(Infrastructure)

RECOMMENDING APPROVAL:

DR. FREDERICK T. VILLA
VP, Administration and Financial Affairs


APPROVED BY:

DR. DORACIE B. ZOZETA-NANTES
University President

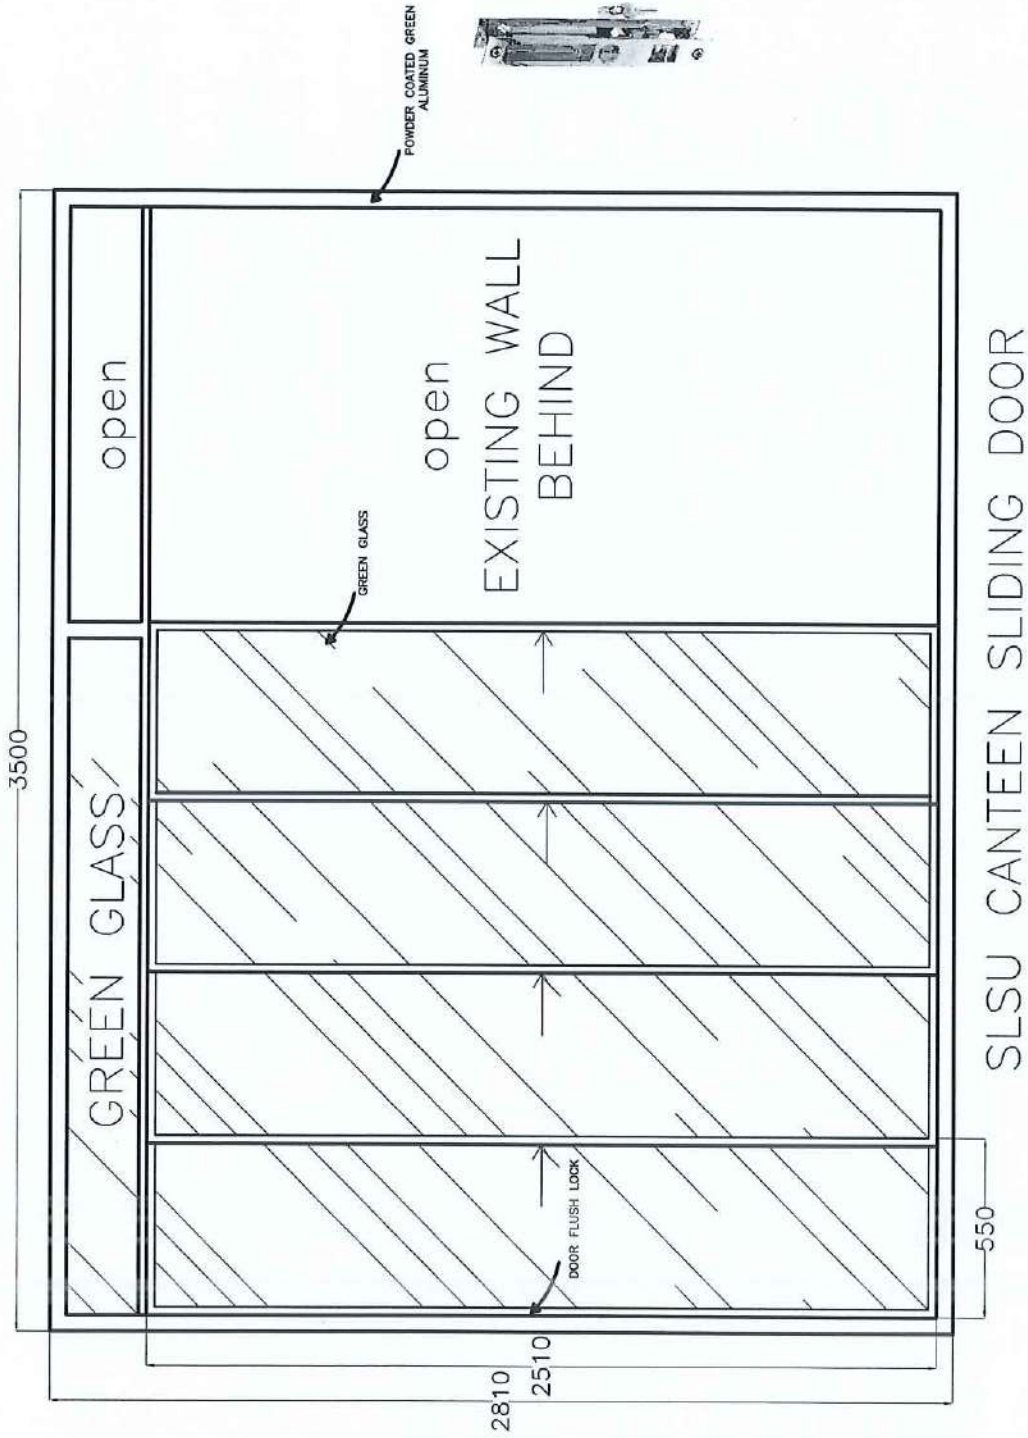

SLSU CANTEEN SLIDING DOOR

| | | | | | | |
|--|--|---|---|---|---|--|
| | <p>PROJECT TITLE Repair, fabrication and installation of Aluminum Sliding Door and Window of Bldg at Ground Floor CUBPA Bldg <small>ADDRESS: 2500 MAIN CAMPUS, LUSKIN, QUEZON</small></p> | <p>PREPARED BY:  ENGR. RONELITO O. SAN JOSE <small>HEAD, POWER, PLUMB AND PAINTER</small></p> | <p>REVIEWED BY:  ENGR. MELVIN A. ARROYAGO <small>DIRECTOR, PLANNING AND DEVELOPMENT OFFICE, INFRASTRUCTURE</small></p> | <p>PROJECT TITLE  FREDERICK T. VILLA, DIT <small>VP. ADMINISTRATION AND FINANCIAL AFFAIRS</small></p> | <p>APPROVED BY:  DORAGIE B. ZOLETA-NAVITES, PHD <small>UNIVERSITY PRESIDENT</small></p> | <p>ALUMINUM SLIDING DOOR</p> <p>1</p> |
|--|--|---|---|---|---|--|

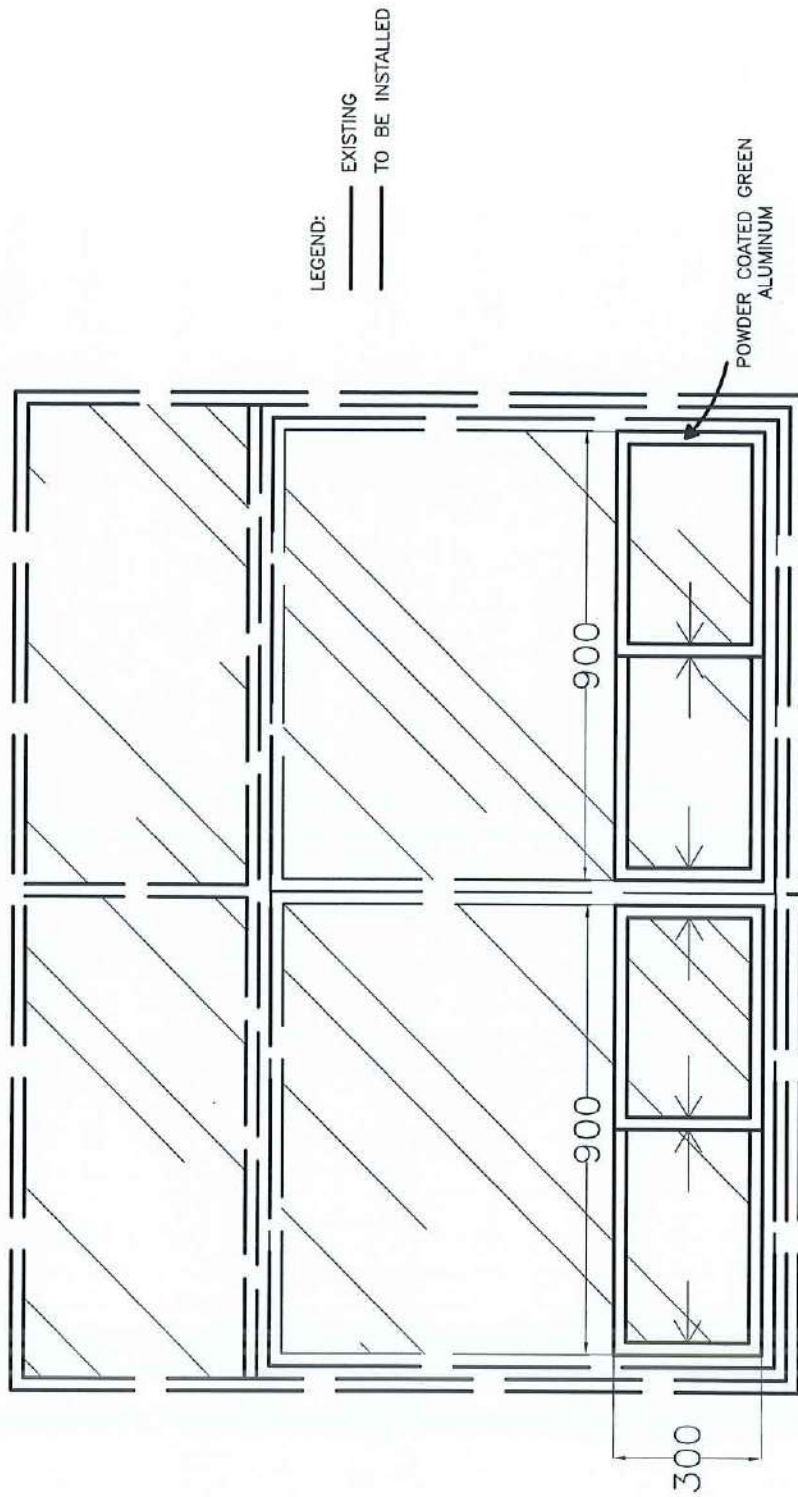

SLSU BAO SLIDING WINDOW
 2 SETS EACH WINDOW
 3 WINDOWS

| | | | |
|---|---|--|--------------------------|
| PROJECT TITLE | REVIEWED BY: | APPROVED BY: | 2 |
| Repair, fabrication and installation of Aluminium Sliding Door and Windows of Bldg at Ground floor CUBPA Bldg | ENGR. RONELITO O. SAN LOISE HEAD, OFFICE OF PLANNING AND EVALUATION OF PROJECTS/INFRASTRUCTURE | FREDERICK V. VILLA, DIT VP, DIVISION OF FINANCIAL AFFAIRS | ALUMINIUM SLIDING WINDOW |
| ADDRESS: SLSU MAIN CAMPUS, LAGUNA QUEDON | ENGR. MELVIN J. RAMPAZAY DIRECTOR, PLANNING AND EVALUATION OF PROJECTS/INFRASTRUCTURE | DORACIE B. ZOLETA-NANTES, PHD UNIVERSITY PRESIDENT | |